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Mono County Community

Development

Mono County Community Development Department

P.O. Box 347 Mammoth Lakes, CA 93546 (760) 924-1800, fax 924-1801 commdev@mono.ca.gov

Planning Division

P.O. Box 8 Bridgeport, CA 93517 (760) 932-5420, fax 932-5431 www.monocounty.ca.gov

WHEELER CREST DESIGN REVIEW DISTRICT PROJECT INFORMATION SHEET

12	SES	SOR PARCEL #
PR	OJE	CT DESCRIPTION (e.g., single-family residence, garage, etc.)
o ou ha	No avoid ilding at the ase	OTE: Please provide all required information as accurately and completely as possible d potential delays in processing. The required information should be shown on the g plans and plot plan. Place a check in the appropriate place on this form to indicate e information has been provided; if certain information does not apply to your project, place "NA" in the appropriate place on this form. INCOMPLETE INFORMATION MAY E PLANS TO BE RESUBMITTED, POSSIBLY ADDING 30 TO 60 DAYS DELAY.
		EXAMPLE
١.		Location of all utility boxes, transformers, propane tanks and metering devices. Please explain how your project complies with the following design criteria: The propane tank is located in
		the rear of the yard (see site map). Native five-gallon conifers will be planted on the north and south side of
		the tanks to shield from view. A wood natural fence, cedar, stained dark brown, four feet high will used on
		the other two sides. The transformer in the front corner of the yard will be shielded by rocks on site with
		juniper bushes on the street side. Irrigation system will be installed.
1.		Location of all utility boxes, transformers, propane tanks and metering devices. Please explain how your project complies with the following design criteria:
		Design Criteria: All utility boxes, transformers, propane tanks and metering devices shall be shielded from public view, where reasonably possible, in accordance with the rules and regulations of the controlling public utility company.
		To be completed by Staff and/or Wheeler Crest Design Review Committee:
		To be completed by Staff and/or Wheeler Crest Design Review Committee: ☐ Complies ☐ Does Not Comply ☐ Not Applicable
		☐ Complies ☐ Does Not Comply ☐ Not Applicable

В.	Paint color for any port above the finished grad		foundation work that extend
	Please explain how your projec	t complies with the following design	criteria (lines on next page):
	Desire Catherine D. (
	as a backing material for design concept. Constru- flat masonry paint on the should be minimized. The the structure. Inappropri- unpainted metal, standar	r veneer work or when used ction grade foundation work to portions extending above to color shall be harmonious	·
	☐ Complies	☐ Does Not Comply	☐ Not Applicable
	Design Review Committee Note	s:	
c.	Design Criteria: Decks structure. The under porto blend with the main structure by Staff and/o	shall be designed to be compartion of elevated decks and potructure or under portions show wheeler Crest Design Review Comparts to the compart of the contract of the compart of the compa	atible with the design of the main brokes shall be painted or stained hall be concealed from view.
	☐ Complies Design Review Committee Note	☐ Does Not Comply s:	☐ Not Applicable
D.	Siding materials and particles are explain how your project of the	or Walls: Generally, only one leads to the applied in a uniform partiate for the area and relate he finatural stone or wood is encor Wheeler Crest Design Review Communication.	kind of siding should be used per ttern or manner. Exterior siding armoniously to existing buildings couraged. mittee:
	☐ Complies	☐ Does Not Comply	☐ Not Applicable

	olor for any aluminu ase explain how your proj	Im sash. ect complies with the following des	ign criteria:
ю	ordinate with the col	ninum sash shall be color-a or theme of the project. For Wheeler Crest Design Review C	
Эе	☐ Complies	☐ Does Not Comply otes:	□ Not Applicable
	int colors for all exasse explain how your proj	ect complies with the following des	ign criteria:
Ple De	ase explain how your proj e sign Criteria: All ex t to blend with the s	ect complies with the following des posed metals, flashing, roof tructure. Muted, nonreflecti	jacks, crickets, etc. are to l ve colors are encouraged.
De fla	ase explain how your proj e sign Criteria: All ex t to blend with the s	ect complies with the following descriptions of the complies with the following descriptions of the complex of	jacks, crickets, etc. are to l ve colors are encouraged.
De fla	esign Criteria: All ext to blend with the state completed by Staff and Complies Sign Review Committee No	ect complies with the following descriptions of the complies with the following descriptions of the complex of	jacks, crickets, etc. are to l ve colors are encouraged. Committee: ☐ Not Applicable
De To Ple	esign Criteria: All ext to blend with the state completed by Staff and Complies Sign Review Committee Notes as explain how your projections.	ect complies with the following descriptions are metals, flashing, roof tructure. Muted, nonreflecting for Wheeler Crest Design Review Comply Does Not Comply otes: ect complies with the following descriptions with the following descriptions with the following descriptions. All types of metal, conview. All types of metal, conview.	jacks, crickets, etc. are to be colors are encouraged. Committee: Not Applicable sign criteria:
De Ple	esign Criteria: All ext to blend with the state completed by Staff and Complies Sign Review Committee Notes as explain how your projections are not exposed to all be reviewed on an interview of the complete in the complet	ect complies with the following descriptions are metals, flashing, roof tructure. Muted, nonreflecting for Wheeler Crest Design Review Comply Does Not Comply otes: ect complies with the following descriptions with the following descriptions with the following descriptions. All types of metal, conview. All types of metal, conview.	jacks, crickets, etc. are to be ve colors are encouraged. Committee: Not Applicable sign criteria: cings will be permitted only imposition and tar-and-gray

н. 🗆		erior stains and finishes. ect complies with the following desi	gn criteria:
	exterior stains and fin over paints. Stains tend shall generally be resurroundings.	ishes giving a natural weatld to weather better and are ϵ	ause of extreme weather conditions, hering appearance are encouraged easier to maintain. The use of color l colors found in the immediate
	☐ Complies	☐ Does Not Comply	☐ Not Applicable
	Design Review Committee No		
I. 🗆	Location of any exteri Please explain how your proje	l or lighting. ect complies with the following design	gn criteria:
	be encouraged.	or Wheeler Crest Design Review Co ☐ Does Not Comply	mized, and indirect lighting should ommittee: Not Applicable
SITE D	DEVELOPMENT		
т. 🗆			ections showing property lines, landscaping, and architectural
	Please explain how your proj	ect complies with the following design	gn criteria:
	directions. The layout harmony with the architobe completed by Staff and	architecture and landscapir itectural theme throughout t I/or Wheeler Crest Design Review Co	ommittee:
	☐ Complies	☐ Does Not Comply	☐ Not Applicable

fill lines from all elev	y required cut and fill (show ations). ject complies with the following design	
for the building, garaş least disturbance pos coverage is minimized natural contours outsi	ling: All reasonable attempts ge and driveways. Foundation sible. Natural, unmodified a for effective erosion control. ' de the footprint of the buildings, post or pile foundations ma	ns shall be designed to createres should be maximized, To the greatest extent possibngs should be retained. In an
Natural or existing top utility of a site ought t	oographic features and patter	rns contributing to the beaut
	l/or Wheeler Crest Design Review Co	mmittee:
	-	☐ Not Applicable
Complies	Does Not Comply	■ Not Applicable
Design Review Committee N	otes:	
Design Review Committee N Location and types o drip trenches, French	otes: f devices to control runoff f	rom impervious surfaces (e
Location and types o drip trenches, French Please explain how your pro	f devices to control runoff for drains, etc.).	From impervious surfaces (egn criteria:
Location and types o drip trenches, Frenches, Please explain how your protest that surface waters we natural drainage flow. Pollution of streams be provided. Runoff from	f devices to control runoff for drains, etc.). ject complies with the following designation attention should be given	from impervious surfaces (egn criteria: to proper site surface drainaboring properties or interference avoided. Erosion control shalriveways) should be accomp
Location and types of drip trenches, Frenches, Frenches explain how your profile that surface waters we natural drainage flow. Pollution of streams be provided. Runoff from by such devices as drip to be completed by Staff and	f devices to control runoff for drains, etc.). ject complies with the following designation adversely affect neighby runoff and siltation shall be impervious surfaces (roofs, of trenches, French drains and the off of the	from impervious surfaces (egn criteria: to proper site surface drainaboring properties or interfered e avoided. Erosion control shalriveways) should be accomped drain channels
Location and types o drip trenches, Frenches, Event Please explain how your protection of streams by provided. Runoff from by such devices as drip to the stream of the st	f devices to control runoff for drains, etc.). ject complies with the following designation adversely affect neighbor yrunoff and siltation shall be impervious surfaces (roofs, of trenches, French drains and for Wheeler Crest Design Review Co	From impervious surfaces (egn criteria: to proper site surface drain boring properties or interfer e avoided. Erosion control shiriveways) should be accomped drain channels


Design Criteria: Fencing: No fence or wall higher than 6 feet tall shall be erected. Fences of simple appearance and construction are the most desirable. Designs that call

	☐ Complies	☐ Does Not Comply	☐ Not Applicable
Ι	Design Review Committee Notes:		
-			
1		ion (location and type on the control of the contro	shrubs to be retained, proportion of plant material), and location ign criteria:
\$ 0 0	enhance the new structure visually objectionable element of trees and large boulders grading shall be replanted control. Trees and shrubs construction by temporar	res and improvements, then the such as utility areas is should be kept to a mind at the earliest seasonal that are to be retained ory fencing or barricades equipment or the stockp	of landscaping or revegetation o strengthen vistas, and to so and trash containers. The renaimum. Ground areas disturbed opportunity to provide for eron the site shall be protected do so that they are not crushed illing of materials, etc. Use of not recommended.
7		ons where this requireme	ated in such a way that no tree and cannot be adhered to, the buts.
i	establishing irrigation for rrigated year round, an id remaining trees, entitling	landscaping beneath the leal environment for root bark beetles to invade as	has evolved in a wet-dry cycle, lese trees is harmful. If the so rot results, thus creating stres and kill the trees. Irrigation sys may retained trees if their surviv
1	An adequate irrigation s necessary. To be completed by Staff and/or	-	nted areas shall be provided
	☐ Complies	☐ Does Not Comp	
			11

PROJECT REVIEW SHEET

(To be completed by Wheeler Crest Design Review Committee and Mono County staff)

APPLICANT	
ASSESSOR PARCEL #	
PROJECT DESCRIPTION	
(e.g., single-family residence, garage, etc.)	
WHEELER CREST DESIGN REVIEW COMMITTEE RECORD Recommended for approval: □ without conditions □ w	
Chair, Wheeler Crest Design Review Committee	Date
The Wheeler Crest Design Review Committee recommends t ☐ Complies with guidelines	he following findings and conditions:
☐ Does not comply with guidelines (please summarize items inconst	istent with guidelines)
Proposed conditions (please recommend conditions to add	ress inconsistencies with guidelines)
COMMUNITY DEVELOPMENT DETERMINATION:	
☐ Hold for further review/information (see attached lette	er for detail)
☐ Approved with no conditions	•
☐ Approved with the following conditions	
Community Development Department	Date

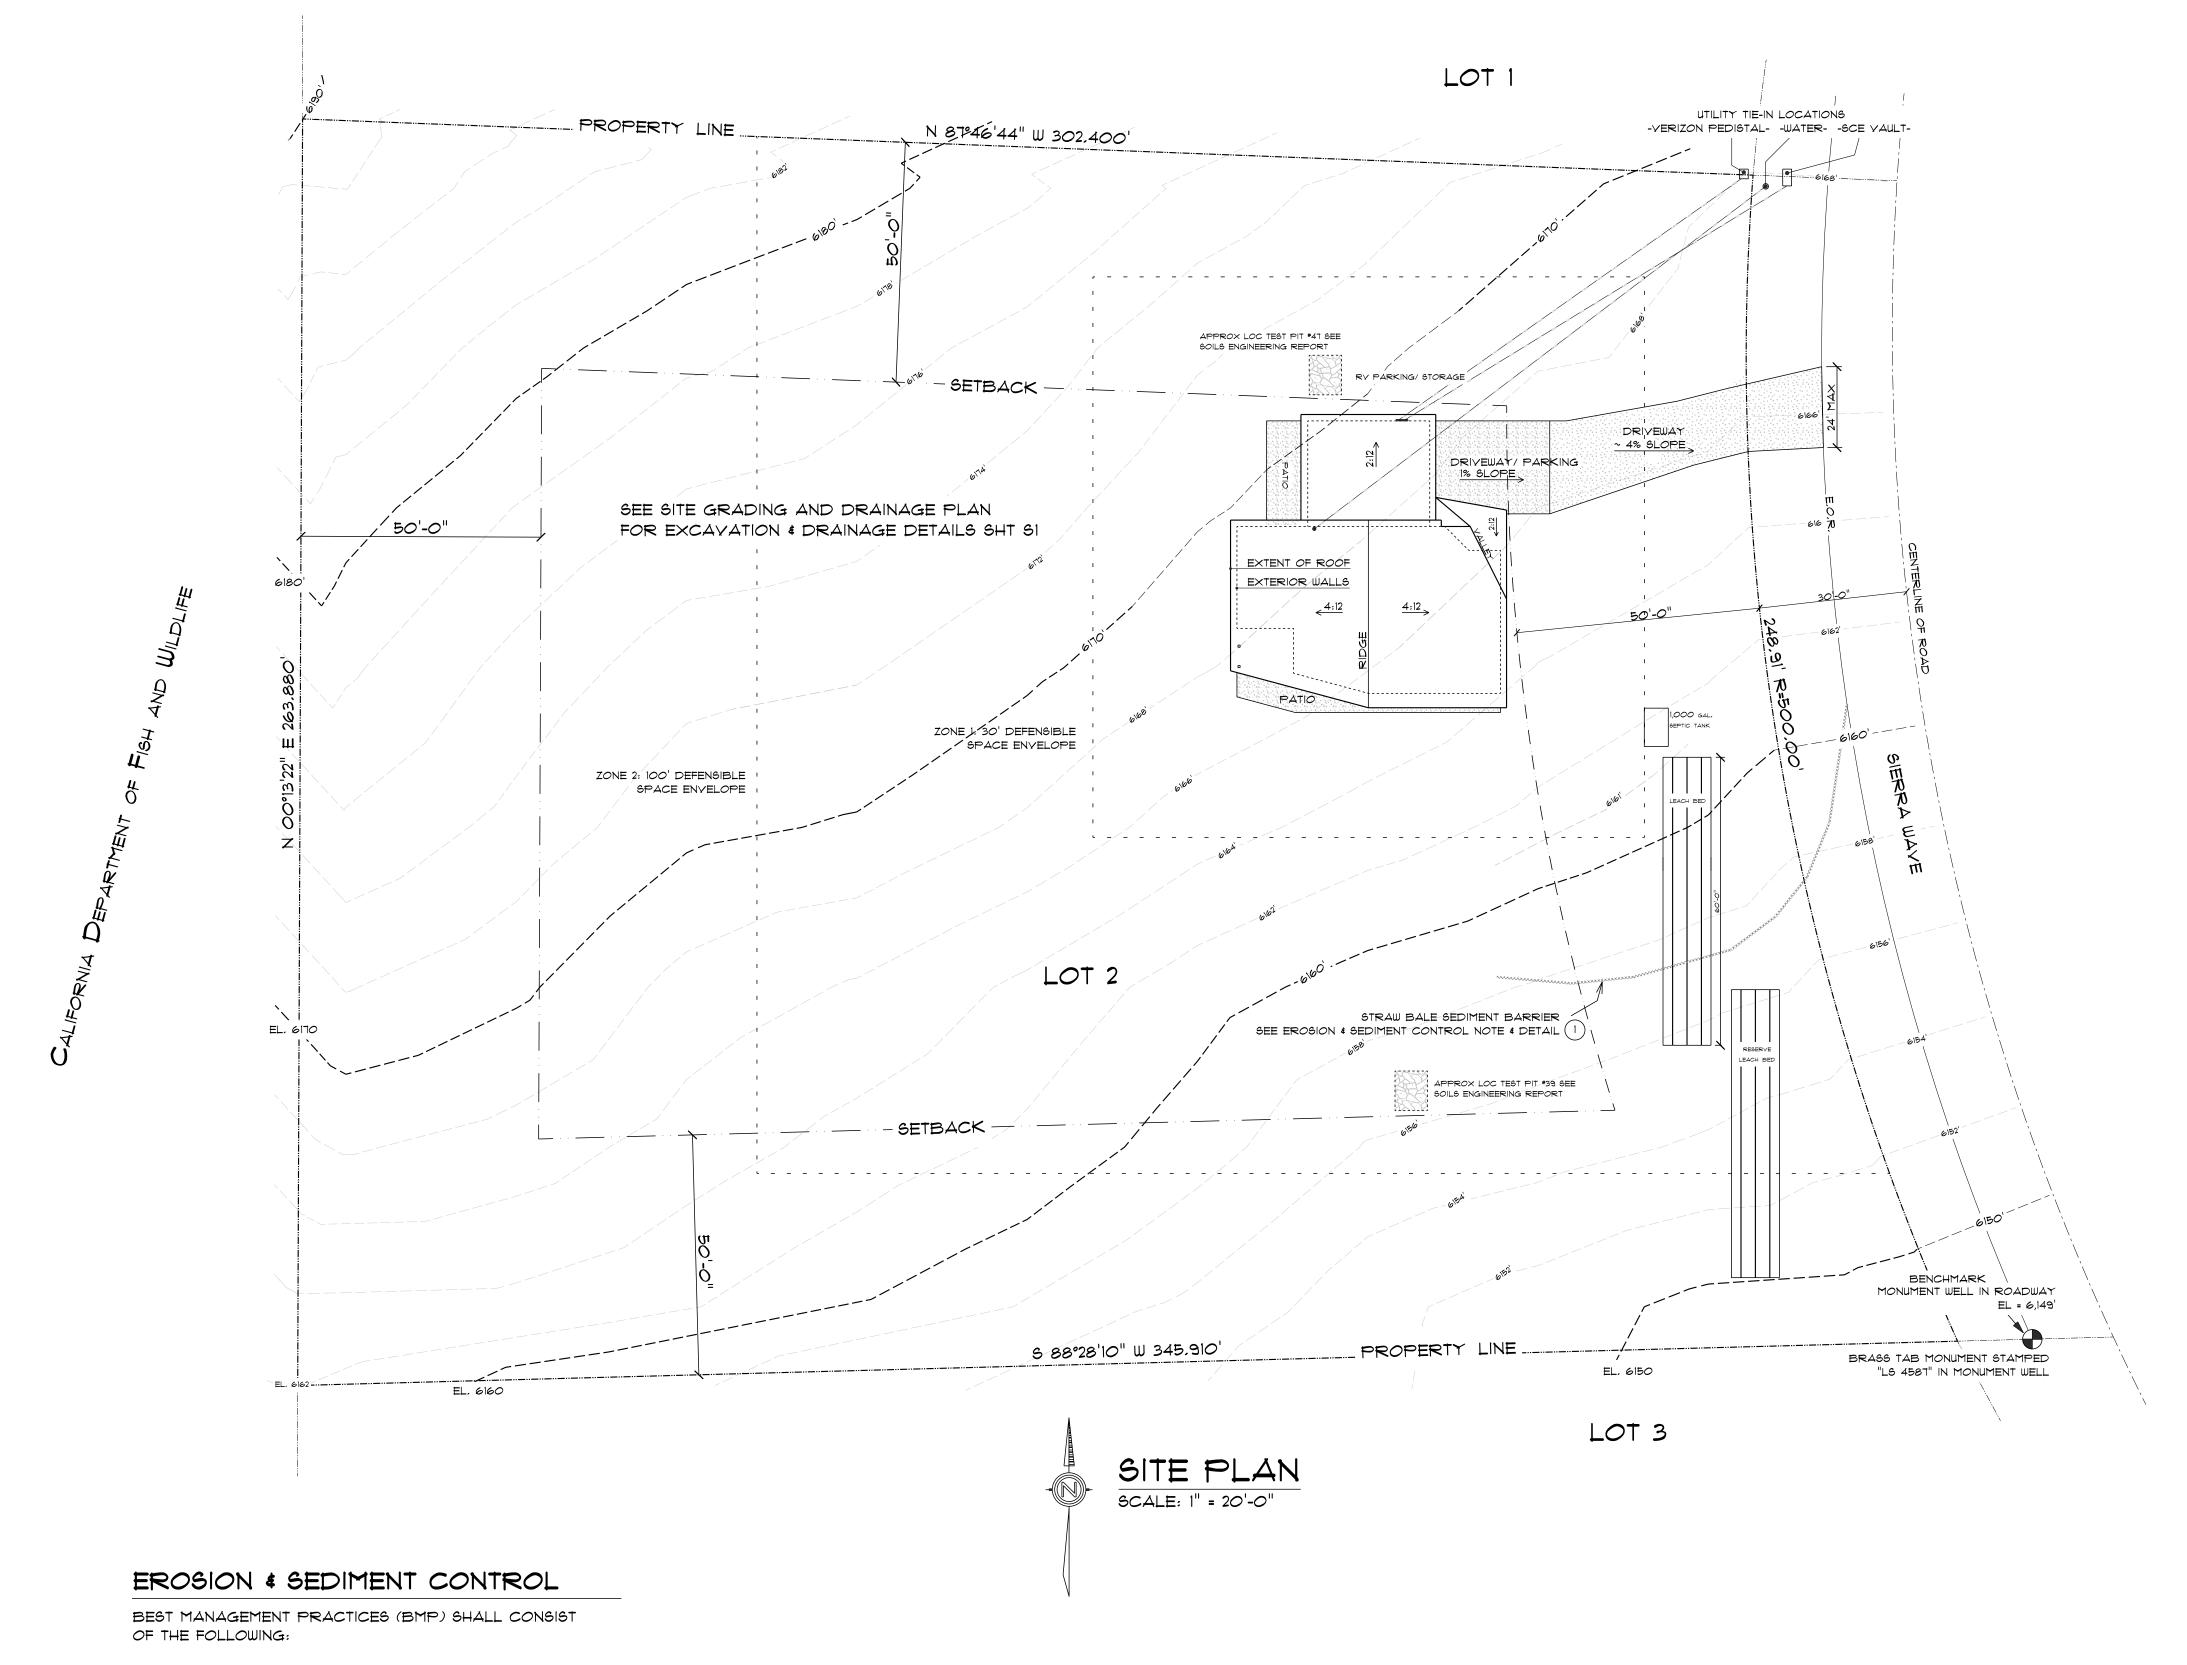

1. DUST CONTROL


 ${\sf S}$ PRINKLING - THE SITE IS SPRINKLED WITH WATER AS NEEDED TO KEEP THE surface moistened to a depth of 2-3 inches, but is not saturated.

2. STRAW BALE SEDIMENT BARRIERS

ROW OF STRAW BALES SHALL BE PLACED ALONG THE CONTOUR OF A GENTLE SLOPE OR AT THE TOE OF A STEEPER SLOPE, THEY CAN BE USED IN THIS WAY AROUND THE DISTURBANCE AREA OR NEAR THE PROPERTY BOUNDARY WHERE RUNOFF FROM THE SITE PASSES ONTO AN ADJACENT PROPERTY,

3. FINAL COYER OF SLOPES

FINAL COVER, SUCH AS VEGETATION, MULCH, ROCK, OR GRAVEL, VEGETATION MUST BE EVENLY DISTRIBUTED AND COVER AT LEAST 70% OF THE DISTURBED area. Alternatively, the disturbed area can be 100% covered by INERT MATERIALS SUCH AS MULCH, ROCK, OR GRAVEL.

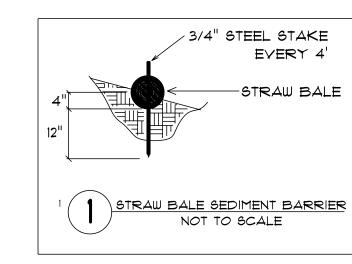

DEFENSIBLE SPACE

PROVIDE ADEQUATE WILDFIRE DEFENSIBLE SPACE AS A FOLLOWS:

ZONE 1 (30' PERIMETER)

A) REMOVE ALL DEAD PLANTS, GRASS, AND WEEDS. B) REMOVE DEAD OR DRY LEAVES AND PINE NEEDLES. C) TRIM TREES REGULARLY TO KEEP BRANCHES A MINIMUM OF 10 FEET FROM OTHER TREES. D) CREATE A SEPARATION BETWEEN TREES, SHRUBS, AND ITEMS THAT COULD CATCH FIRE, SUCH AS PATIO FURNITURE, WOOD PILES, SWING SETS, ETC.

ZONE 2 (100' PERIMETER) A) CUT OR MOW ANNUAL GRASS DOWN TO A MAXIMUM

HEIGHT OF FOUR INCHES. B) CREATE HORIZONTAL SPACE BETWEEN SHRUBS AND TREES, (SEE DIAGRAM)

C) CREATE VERTICAL SPACE BETWEEN GRASS, SHRUBS AND TREES, (SEE DIAGRAM) D) REMOVE FALLEN LEAVES, NEEDLES, TWIGS, BARK,

CONES, AND SMALL BRANCHES. HOWEVER, THEY MAY BE PERMITTED TO A DEPTH OF THREE INCHES. E) KEEP 10 FEET OF CLEARANCE AROUND EXPOSED WOOD PILES, DOWN TO BARE MINERAL SOIL, IN ALL DIRECTIONS. F) CLEAR AREAS AROUND OUTBUILDINGS AND PROPANE TANKS, KEEP 10 FEET OF CLEARANCE TO BARE MINERAL SOIL AND NO FLAMMABLE VEGETATION FOR AN ADDITIONAL 10 FEET AROUND THEIR EXTERIOR.

PLUM DESIGN \$ CONSTRUCTION


2620 SIERRA VISTA WAY BISHOP, CA 93514

PLUMDESIGN2003@GMAIL.COM 760.965.6698

DRAWN BY: JSP CA. Lic. # 875346

		1		
	<u>"</u>	#	PROJECT INFORMATION:	
-		F	WESTERN RESIDENCE	
		REVISIO	OWNER:	
Å		ON R	JIM & JOAN WESTERN RESIDENCE	
		ECOF	514 AMERICAS WAY #4730 LOT #2 SIERRA WAVE	111
		RD	BOX ELDER, SD 57719 BOX ELDER, SD 57719 CA	4 93514
		DATE	SITE PLAN	
		f		-

SCALE: As NOTED

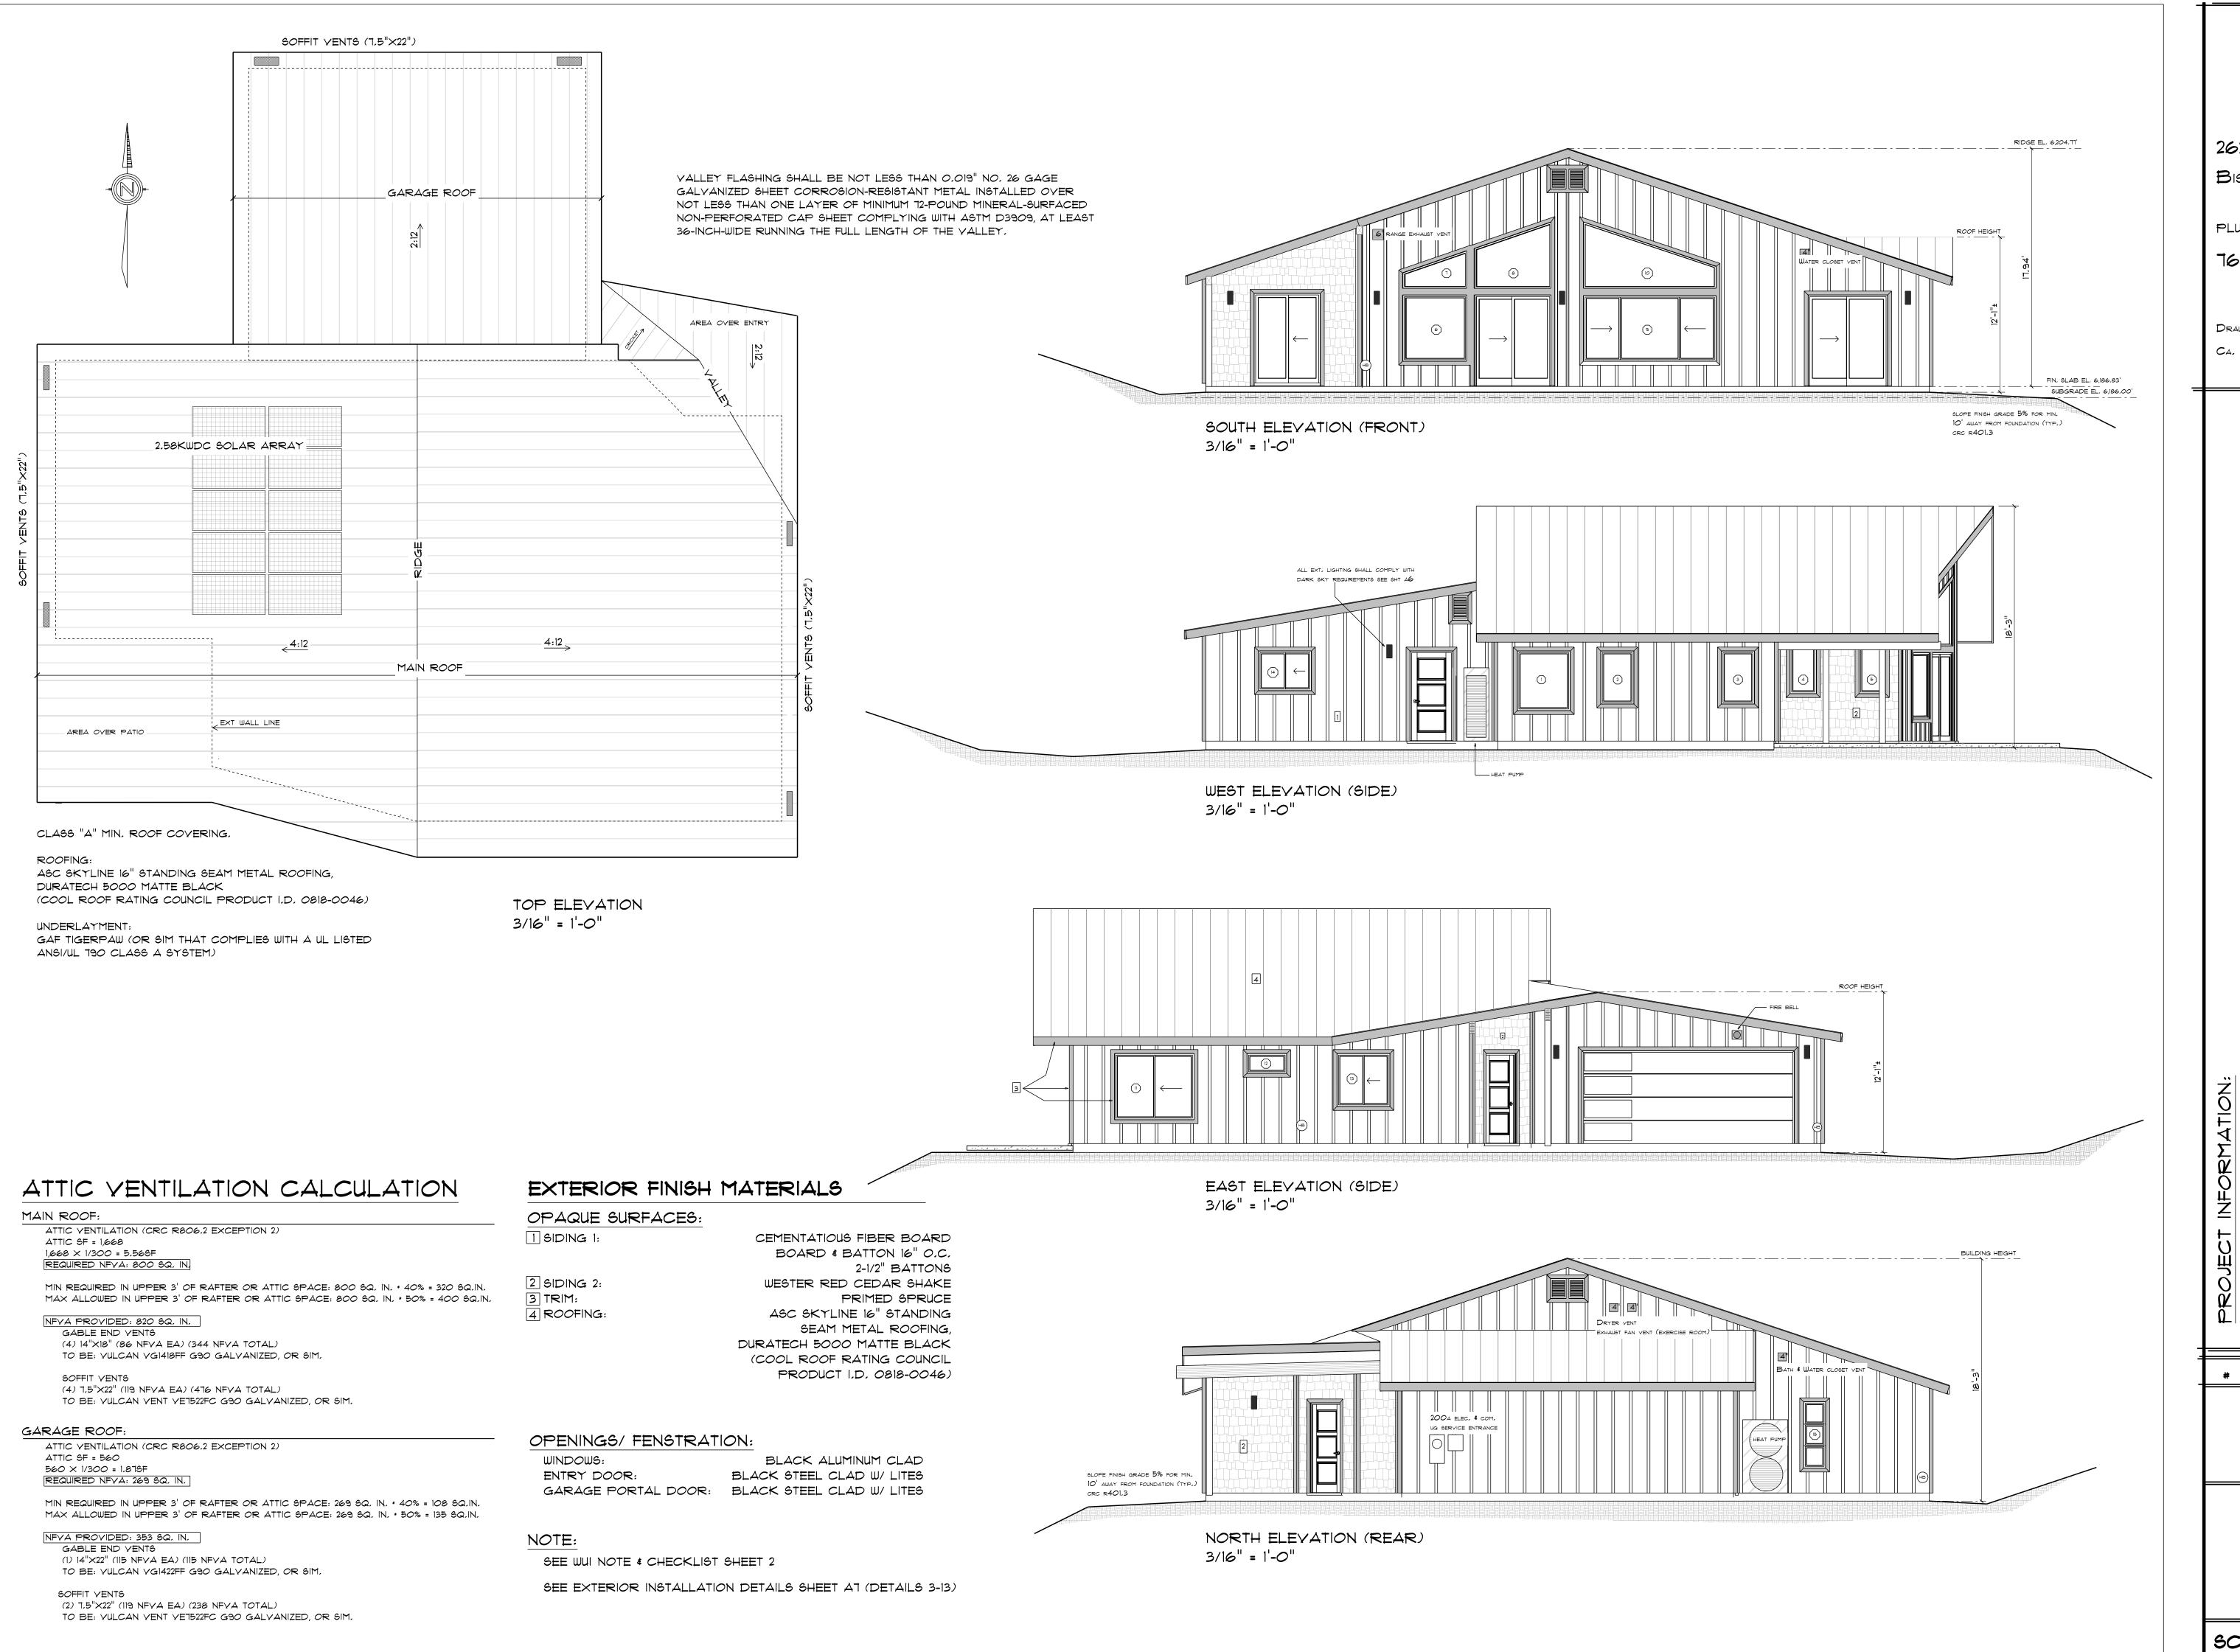

PLUM DESIGN \$ CONSTRUCTION


2620 SIERRA VISTA WAY BISHOP, CA 93514

PLUMDESIGN2003@GMAIL.COM 760.965.6698

11/20/2023 DRAWN BY: JSP CA, Lic. # 875346

INFORMATION: 3 D 山 REVISION RECORD DATE

SCALE: As NOTED

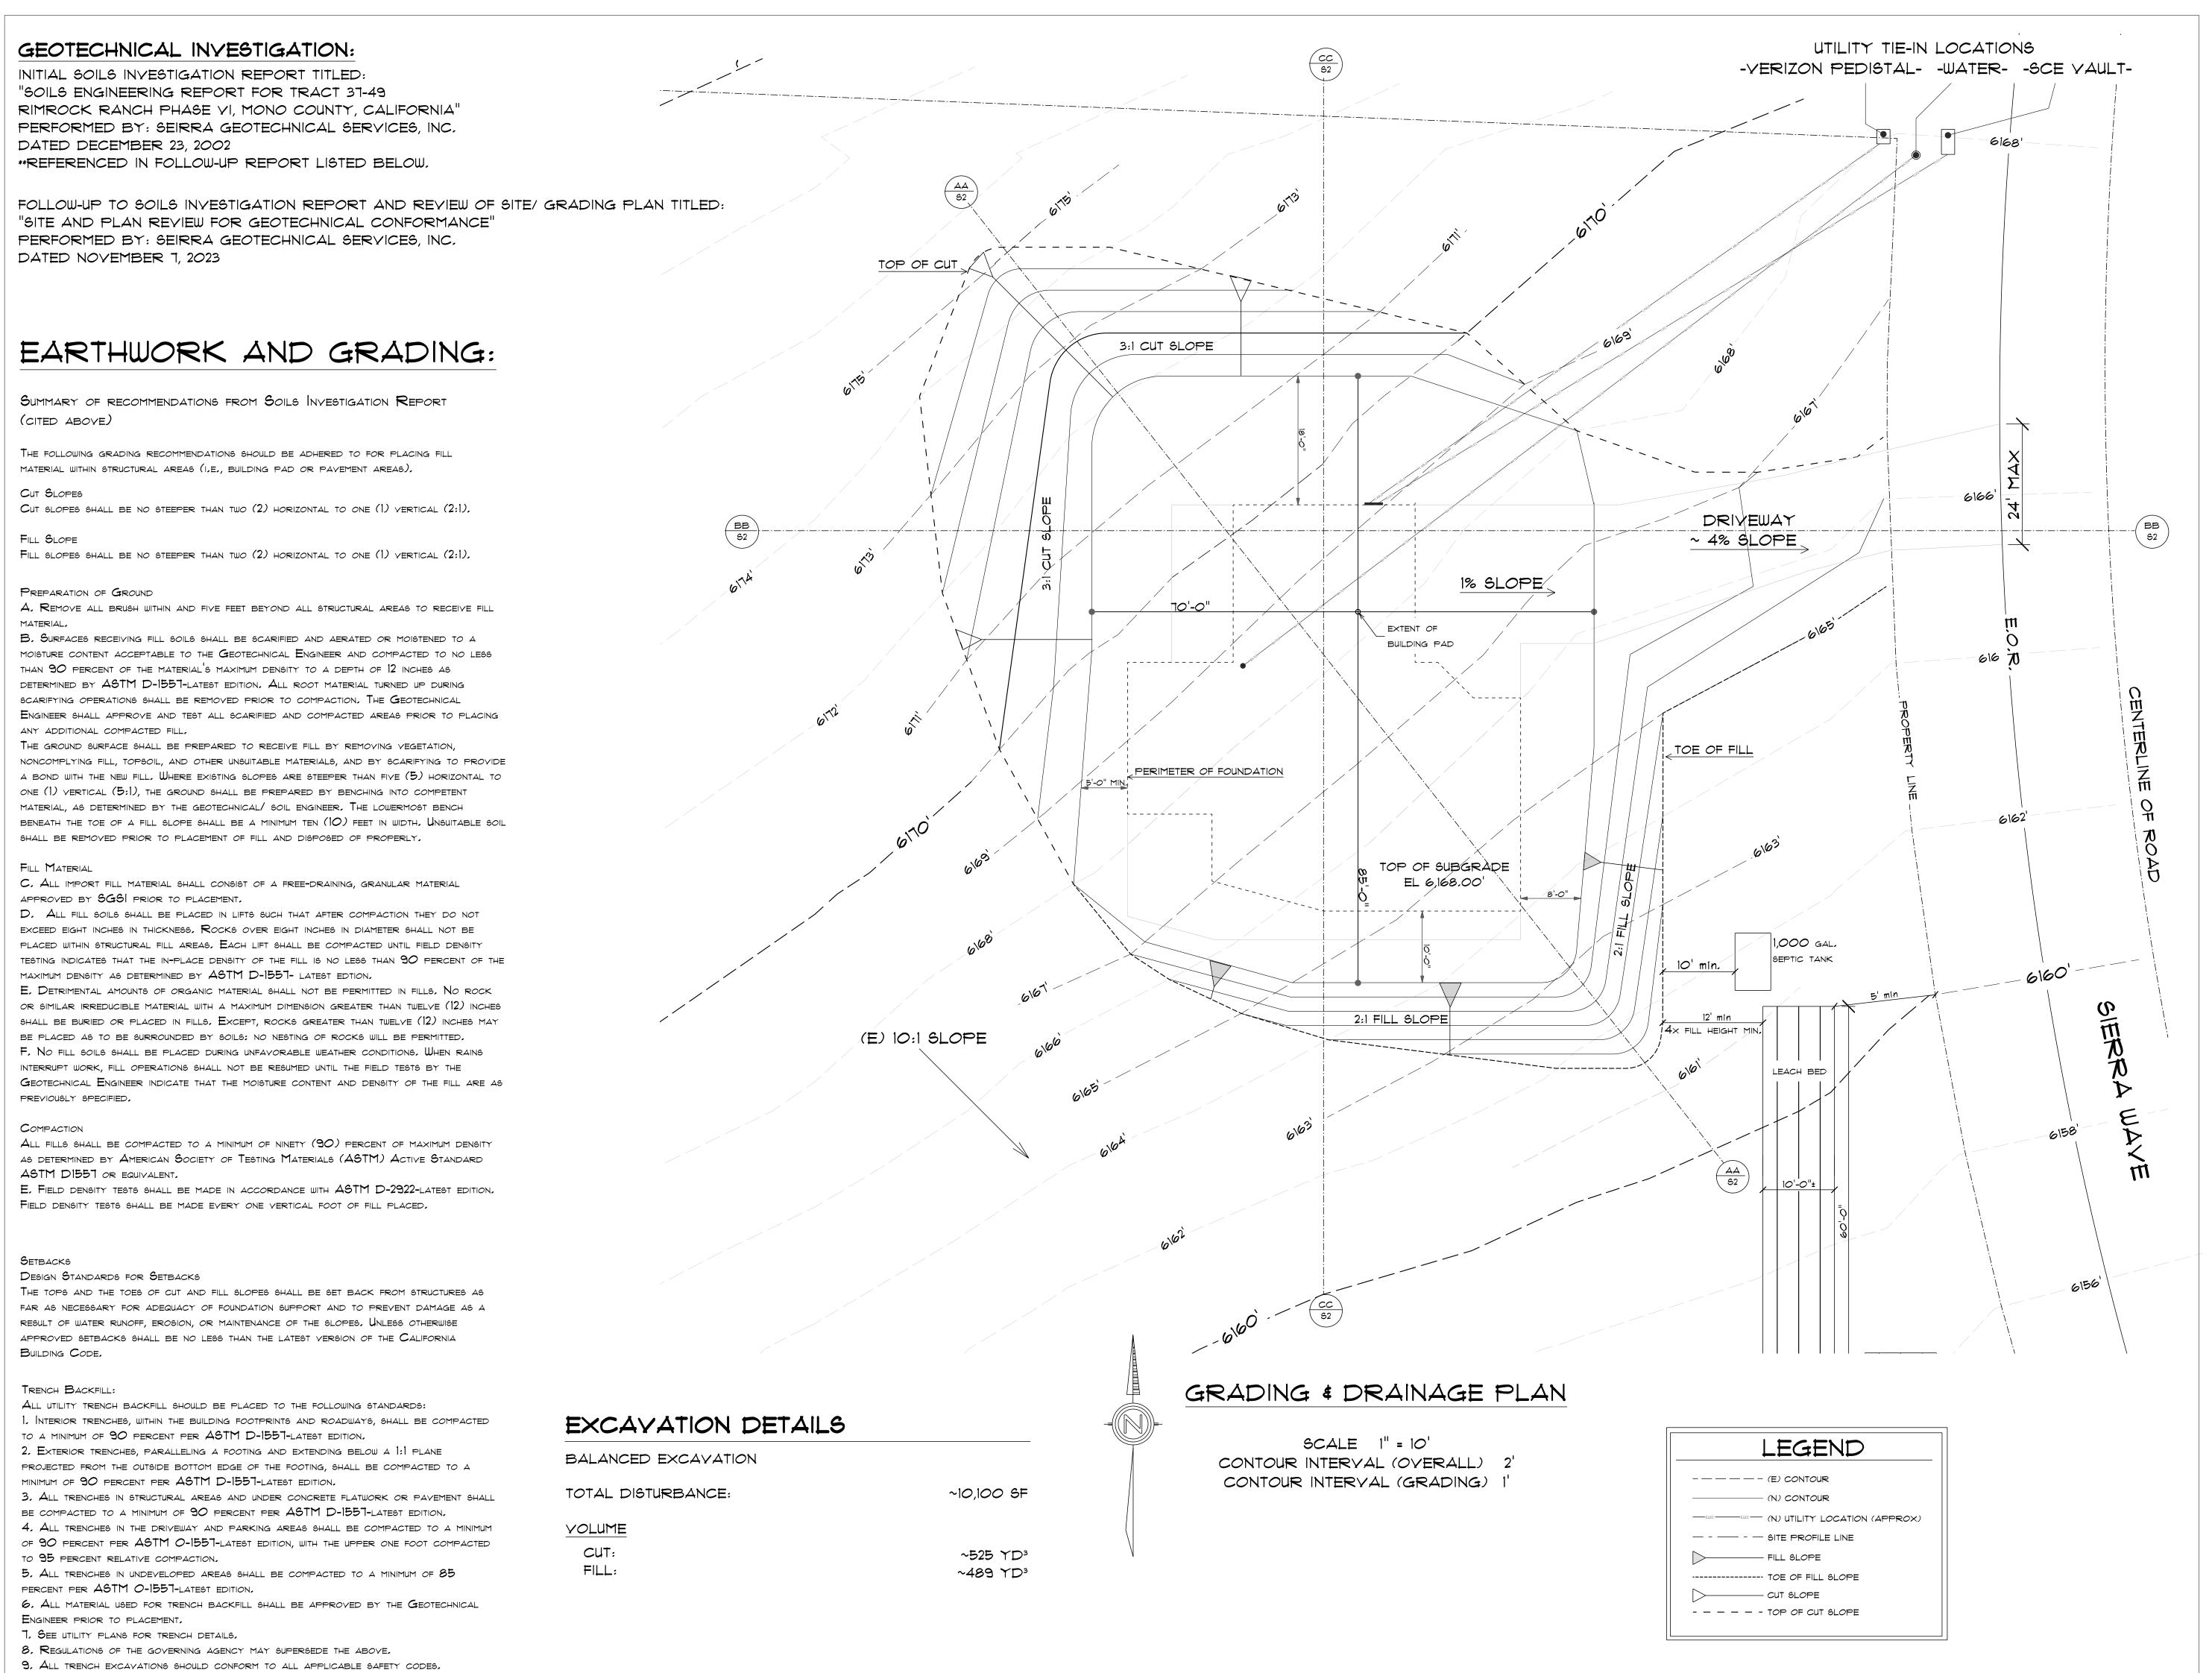

Plum Design & Construction

2620 SIERRA VISTA WAY BISHOP, CA 93514

PLUMDESIGN2003@GMAIL.COM 760.965.6698

DRAWN BY: JSP 11/20/2023

CA. Lic. # 875346

PROJECT INFORMATION:

WESTERN RESIDENCE

OWNER:

JIM & JOAN WESTERN

514 AMERICAS WAY *4130

BOX ELDER, SD 57119

GTE GRADING & DRAINAGE P

51

SCALE: As NOTED

MINIMUM BURIAL DEPTHS

GENERAL

Trenches shall be backfilled in thin layers to 12" above the top of the piping with clean earth, which shall not contain stones, boulders, cinderfill, frozen earth, construction debris, or other materials that will damage or break the piping or cause corrosive action. (CPC 314.4, CEC 300.5(F)))

Trenches deeper than the footing of a building or structure, and paralleling the same, shall be located not less than 45 degrees from the bottom exterior edge of the footing. (CPC 314.1)

ELECTRICAL

SEE CEC TABLE 300,5 FOR ELECTRICAL WIRING/CONDUIT MINIMUM COVER REQUIREMENTS,

For underground conductors buried $18^{"}$ or more below grade, a warning ribbon shall be placed at the trench $12^{"}$ above the underground installation. (CEC 300.5(D))

PLUMBING (GAS)

Underground gas piping shall be installed with a cover of not less than 12". Where external damage to the pipe or tubing is likely to result, the cover shall not be less than 18". (CPC 1210.1.1)

O FOR PLASTIC PIPING, AN ELECTRICALLY CONTINUOUS CORROSION-RESISTANT TRACER WIRE (NOT LESS THAN 14 AWG) OR TAPE SHALL BE BURIED WITH THE PLASTIC PIPE TO FACILITATE LOCATING. (CPC 1210.1.7.2)

PLUMBING (SEWER AND WATER)

Sanitary sewer and water piping (except as noted below) shall have a minimum burial depth of $12^{\prime\prime}$. (CPC 314.4)

Installation of thermoplastic pipe and fittings shall be made on a trench 1.25 times the outside diameter of the piping plus 16". (CPC 314.4.1)


PLASTIC WATER PIPING SHALL HAVE A BLUE INSULATED COPPER TRACER WIRE OR OTHER APPROVED CONDUCTOR INSTALLED ADJACENT TO THE PIPING; THE TRACER WIRE SHALL NOT BE LESS THAN 18 AUG AND THE INSULATION TYPE SHALL BE SUITABLE FOR DIRECT BURIAL, (CPC 604.10.1)

Water pipes shall not be run or laid in the same trench as building sewer or drainage piping constructed of clay or materials that are not approved for use within a building unless the following conditions are met (CPC 609.2):

- O The bottom of the water piping shall not be less than $12^{\prime\prime}$ above the top of the sewer or drain
- O THE WATER PIPE SHALL BE PLACED ON A SOLID SHELF EXCAVATED AT ONE SIDE OF THE COMMON TRENCH WITH A CLEAR HORIZONTAL DISTANCE OF NOT LESS THAN 12" FROM THE SEWER OR DRAIN LINE,


COMMUNICATION

No DEPTH REQUIREMENTS.

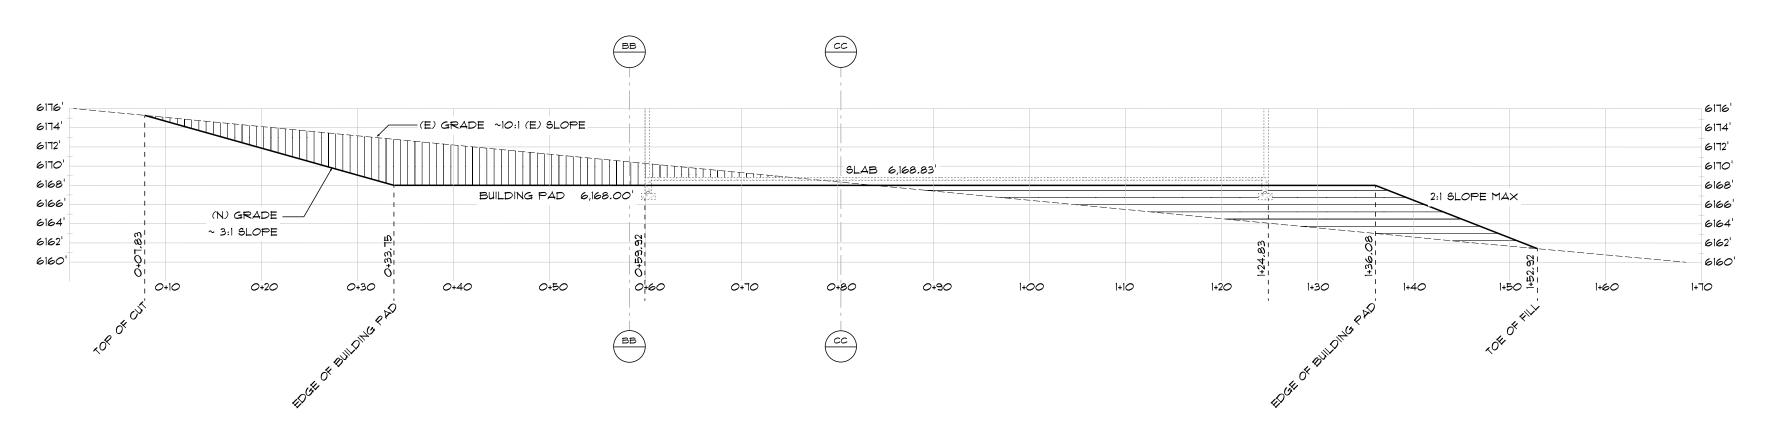


SITE PROFILE - AA

1" = 10'-0"

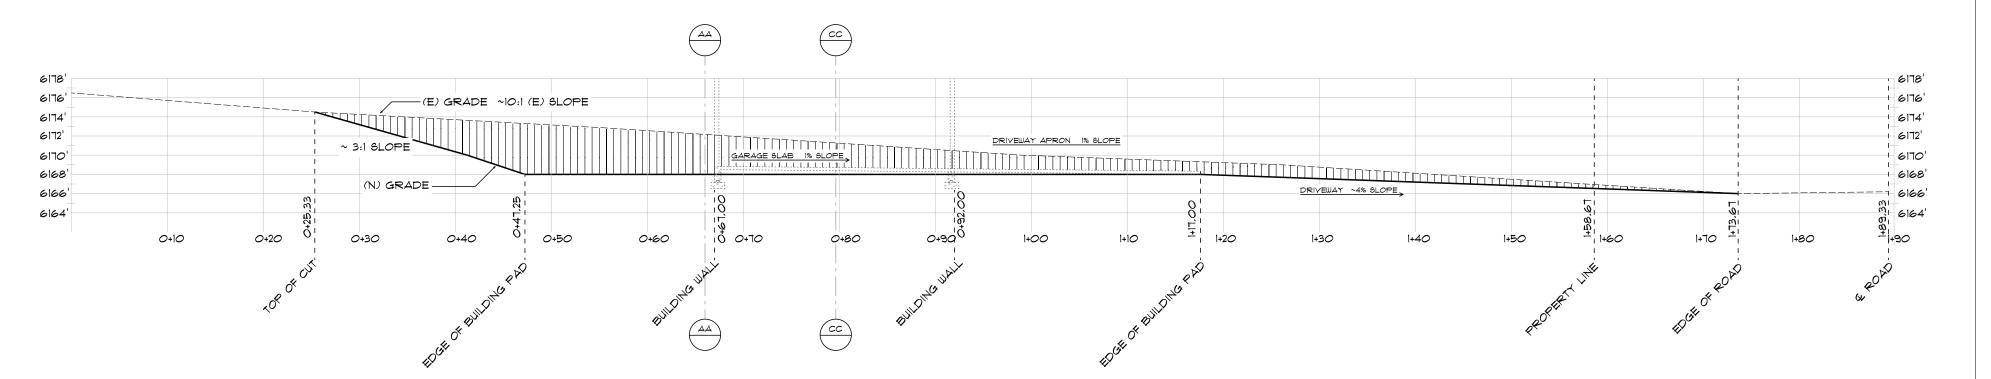

SITE PROFILE - BB (WEST/EAST THRU GARAGE & DRIVEWAY)

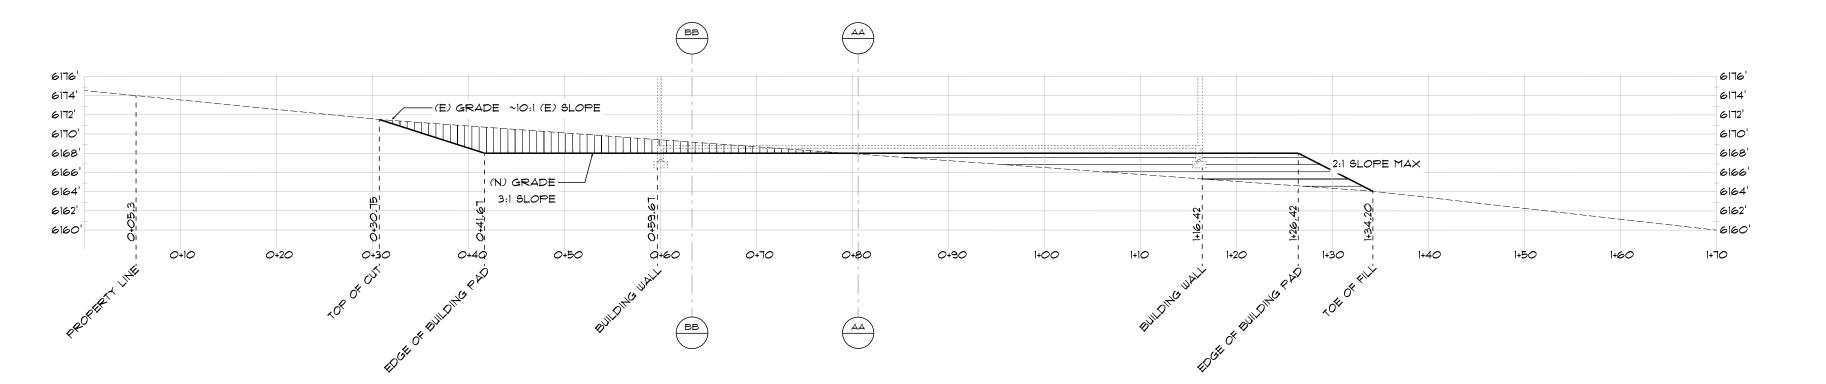

SITE PROFILE - CC (NORTH/SOUTH @ CENTER OF BUILDING)

1" = 10'-0"

NOTE:

- BUILDING ILLUSTRATED FOR REFERNCE ONLY, SEE ARCHITECTUAL & STRUCTURAL DRAWINGS FOR DETAILS,

Plum Design & Construction

2620 SIERRA VISTA WAY BISHOP, CA 93514

PLUMDESIGN2003@GMAIL.COM 760.965.6698

DRAWN BY: JSP 11/20/2023 Ca, Lic. # 875346

#	PROJECT INFORMATION:	
- F	Western Residence	
REVISIO	O WNER:	PROJECT SITE:
	JIM & JOAN WESTERN	Western Residence
	514 AMERICAS WAY #4730	LOT #2 SIERRA WAVE
	BOX ELDER, SD 57719	SWALL MEADOWS, CA 93514
DATE	SITE PROFILES	

S2

SCALE: As NOTED

|1/20/2023 06:28 AM