

SCALE: 1" = 10'

TWIN LAKES SUBDIVISION

BLOCK

LOT #

A.P.N. 010-361-018-000

ACREAGE 0.25

SFR / NA ZONING

SETBACKS: FRONT

REAR - 30' PER CAL. FIRE

FLOOD ZONE: X-UNSHADED

35 LAKE SHORE DRIVE TWIN LAKES, CA. PHYSICAL ADDRESS:

PROPOSED 420 SQ. FT. DETACHED GARAGE

FOR:

JAMIE HAWKINS

THIS IS NOT A SURVEY. THIS SITE PLAN WAS PREPARED BASED UPON TOPOGRAPHIC INFORMATION PROVIDED BY OTHERS. THE CONTRACTOR OF RECORD SHALL VERIFY EXISTING SITE CONDITIONS PRIOR TO COMMENCEMENT OF ANY WORK. IF EXISTING CONDITIONS DIFFER FROM THOSE SHOWN ON THIS PLAN, BUILDING CONCEPTS, INC. SHALL BE NOTIFIED PRIOR TO COMMENCEMENT OF ALL WORK.

NOTE: DESIGNER / ENGINEER IS NOT RESPONSIBLE FOR ACCURACY OF EXISTING UTILITY LOCATIONS SHOWN. OWNER / CONTRACTOR TO FIELD VERIFY & LOCATE ALL UTILITIES PRIOR TO CONSTRUCTION. OWNER / CONTRACTOR TO CONTACT DESIGNER IMMEDIATELY IF UTILITY LOCATIONS CONFLICT WITH PROPOSED CONSTRUCTION.

UPGRADES TO CONFORM W/ CURRENT CODES OR MUNICIPALITY REQUIREMENTS MAY BE REQUIRED AFTER EXISTING UTILITY INFORMATION IS DISCOVERED.



BUILDING CONCEPTS INC. "METICULOUS ENGINEERING UNPARALLELED DESIGN" 1605 Mono Ave. Minden, N.V. 89423 Phone: (775) 782-8886 Fax: (775) 782-8833

www.bldgconcepts.com

BUILDING CONCEPTS, INC. HEREBY RESERVES IT'S COMMON LAW COPYRIGHT AND OTHER PROPERTY RIGHTS IN THESE PLANS, IDEAS, AND DESIGNS, THESE IDEAS, DESIGNS, AND PLANS ARE NOT TO BE REPRODUCED CHANGED, OR ASSIGNED TO ANY THIRD PARTY WITHOUT FIRST OBTAINING WRITTEN PERMISSION FROM BUILDING CONCEPTS, INC.

© BUILDING CONCEPTS, INC. 2022


IIE HAWKINS 8 CINTHIA STREET AESA, CA., 91941 19) 572-4296 JAMII 7928 La MI (61)

**REVISIONS** 

FEBRUARY 29, 2024 23176 23176C1.0 1" = 10'-0" DCM SCALE: DRAWN BY:

HAWKINS GARAGE

SHEET

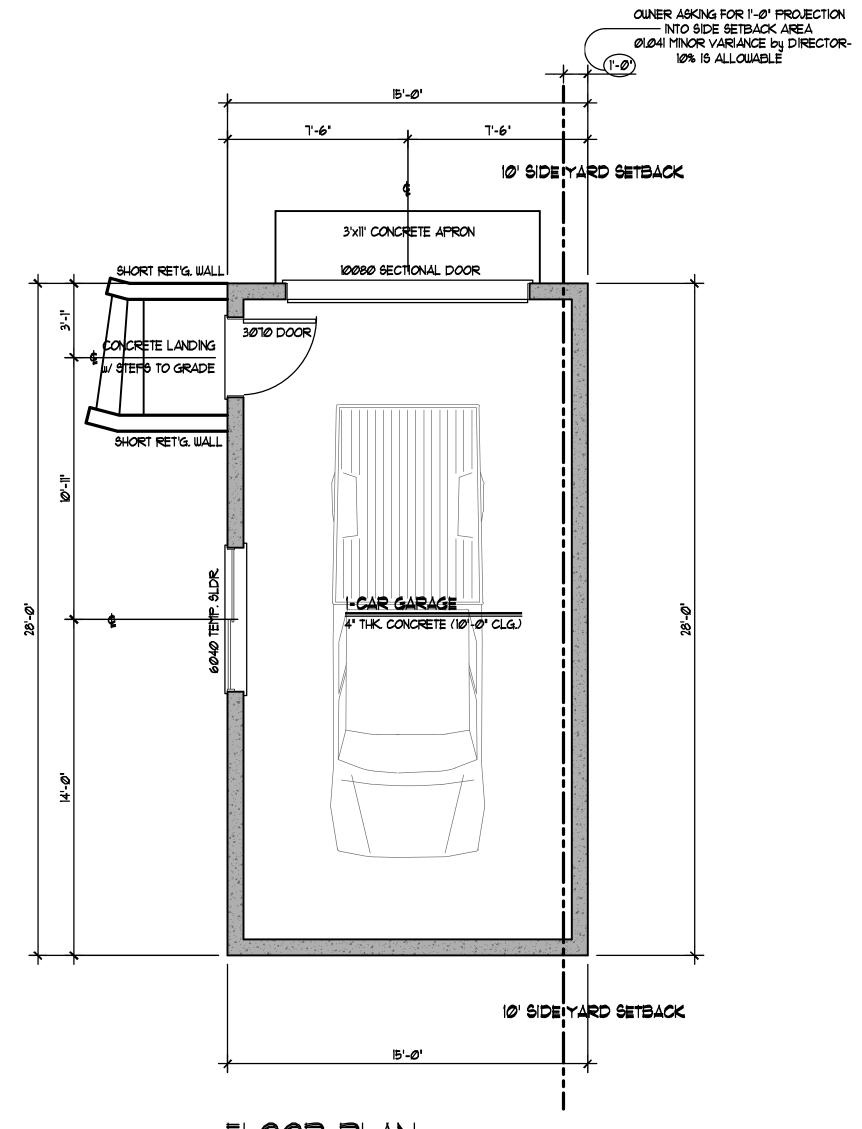

FLOOR PLAN

420 SQ. FT. - 1 CAR GARAGE

SCALE: 1/4'=1'-@'

PROVIDE LANDINGS W/ A MIN. CLEARANCE OF 36' INCHES IN THE DIRECTION OF TRAVEL. PER THE 2022

IF EXISTING CONDITIONS DIFFER FROM THAT WHICH IS STATED ON PLANS PLEASE

NOTIFY PROJECT ENGINEER ACCORDINGLY

WINDOW FALL PROTECTION:

CRC SECTION R311.3

WINDOW FALL PROTECTION SHALL BE PROVIDED IN ACCORDANCE WITH SECTIONS R312.2.1 4 R312.22.

WINDOW SILLS IN DWELLING UNITS, WHERE THE OPENING OF AN OPERABLE WINDOW IS LOCATED MORE THAN 12' ABOVE FINISHED GRADE OR SURFACE BELOW, THE LOWEST PART OF THE CLEAR OPENING OF THE WINDOW SHALL BE A MINIMUM OF 24' ABOVE THE FINISHED FLOOR OF THE ROOM IN WHICH THE WINDOW IS LOCATED. OPERABLE SECTIONS OF WINDOWS SHALL NOT PERMIT OPENINGS THAT ALLOW PASSAGE OF A 410 SPHERE WHERE SUCH OPENINGS ARE LOCATED WITHIN 24" OF THE FINISHED FLOOR

EXCEPTIONS:

• WINDOWS THAT WILL NOT ALLOW A 4" • SPHERE

- TO PASS THROUGH THE OPENING WHEN THE OPENING IS IN ITS LARGEST OPENED POSITION. OPENINGS THAT ARE PROVIDED WITH WINDOW FALL PREVENTION DEVICES THAT COMPLY WITH ASTM F 2090.
- WINDOWS THAT ARE PROVIDED WITH WINDOW OPENING CONTROL DEVICES THAT COMPLY WITH SECTION R312.22.

AUTOMATIC GARAGE DOOR OPENERS: SHALL BE LISTED AND LABELED IN ACCORDANCE WITH UL 325 PER CRC R309.4

SAFETY GLAZING MUST BE USED IN ALL HAZARDOUS AREAS PER 2022 CRC SECTION R308 ALL NEW GLAZING WILL BE INSTALLED WITH LABELS TO

REMAIN IN PLACE FOR INSPECTION. THE LOAD RESISTANCE OF GLASS UNDER UNIFORM

ASTM E1300. PROVIDE LIGHT AND VENTILATION PER THE 2022 CRC

LOAD SHALL BE DETERMINED IN ACCORDANCE WITH

SECTION R303. PROVIDE ATTIC ACCESS OPENING A MIN. OF 22 INCHES BY 30 INCHES AND LOCATED IN A CORRIDOR, HALLWAY OR OTHER READILY ACCESSIBLE LOCATION. A MINIMUM OF 30 INCHES UNOBSTRUCTED HEADROOM IN THE ATTIC

PER 2022 CRC SECTION R801. ALL LUMBER SHALL BE DOUGLAS FIR NO. 2 (DF\*2) GRADE OR BETTER UNLESS NOTED OTHERWISE.

SHALL BE PROVIDED AT OR ABOYE THE OPENING.

MEASUREMENTS ARE TO STUD FACE UNLESS NOTED OTHERWISE. JOINTS & PENETRATIONS SHALL BE CAULKED & SEALED

(020) OF ONE PERCENT (1%) ARE PROHIBITED IN

- PROVIDE WEATHER STRIPPING AROUND DOORS AND WINDOWS. ALL SOLDERS & FLUXES SHALL BE MANUFACTURED TO APPROYED STANDARDS. SOLDERS & FLUXES WITH A LEAD CONTENT WHICH EXCEEDS TWO-TENTHS

PIPING SYSTEMS USED TO CONVEY POTABLE OCCUPANCY SEPARATIONS SHALL BE OF SUCH FORM AS MAY BE REQUIRED TO AFFORD A COMPLETE

SEPARATION BETWEEN THE VARIOUS OCCUPANCIES OF THE BUILDING. BALCONIES, LANDINGS, EXTERIOR STAIRWAYS, OCCUPIED ROOFS & SIMILAR SURFACES EXPOSED TO THE WEATHER & SEALED UNDERNEATH SHALL BE

WATERPROOFED & SLOPED A MINIMUM OF 1/4" UNIT

DRAINAGE. PER 2022 CRC SECTION R311.

VERTICAL IN 12 UNITS HORIZONTAL (2% SLOPE) FOR

BUILDING CONCEPTS INC. "METICULOUS ENGINEERING UNPARALLELED DESIGN" 1605 Mono Ave. Minden, N.V. 89423 Phone: (775) 782-8886 Fax: (775) 782-8833

www.bldgconcepts.com

BUILDING CONCEPTS, INC. HEREBY RESERVES IT'S COMMON LAW COPYRIGHT AND OTHER PROPERTY RIGHTS IN THESE PLANS, IDEAS, AND DESIGNS. THESE IDEAS, DESIGNS, AND PLANS ARE NOT TO BE REPRODUCED CHANGED, OR ASSIGNED TO ANY THIRD PARTY WITHOUT FIRST OBTAINING WRITTEN PERMISSION FROM BUILDING CONCEPTS, INC. © BUILDING CONCEPTS, INC. 2022


JAMI 7928 La MI (61)

REVISIONS

FEBRUARY 29, 2024 JOB# FILE: 23176*A*LI SCALE: 14" = 1'-0" DRAWN BY: DCM

> GARAGE 35 LAKESHORE DRIVE BRIDGEPORT, CA. APN: # 010-361-018-000 HAWKINS

SHEET

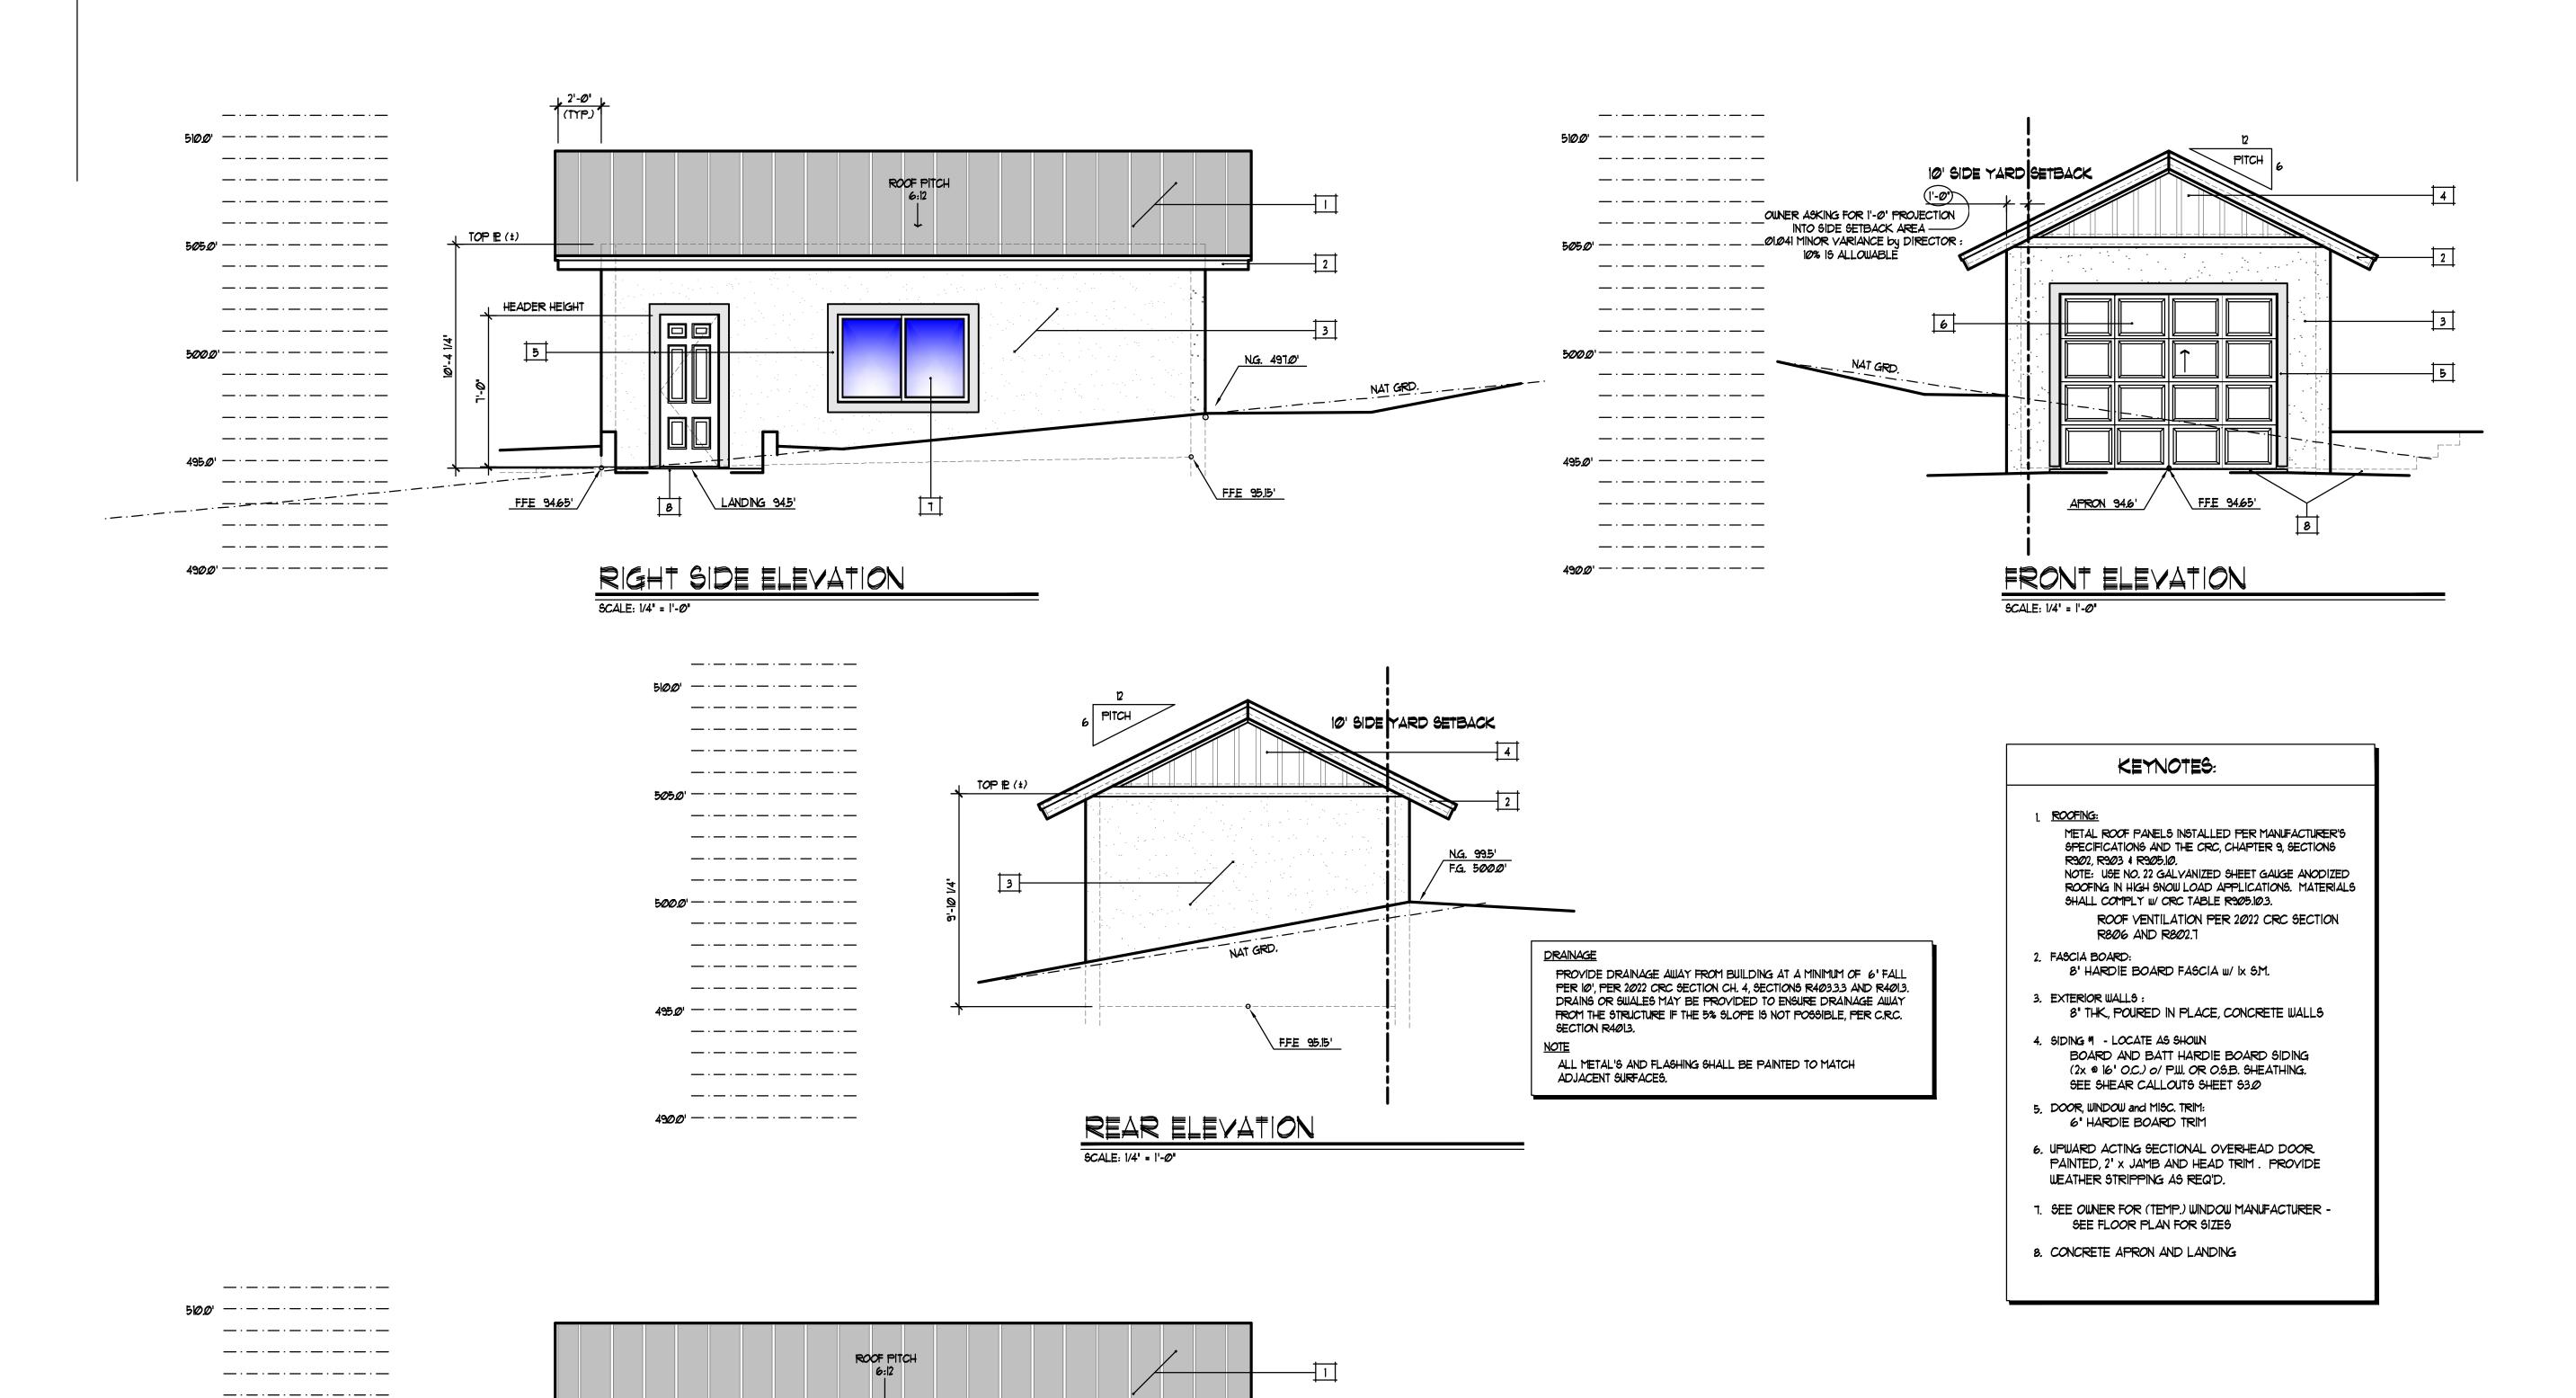

505.0' - - - - - - - - - - - - - - -

\_-----

\_-----\_-----

\_-----

\_ . \_ . \_ . \_ . \_ . \_ . \_ . \_ . \_ . \_-----

495.0' -----

4900' -----

N.G. 99.5' F.G. 500.0'

FFE 95.15'

LEFT SIDE ELEVATION

SCALE: 1/4" = 1'-0"



BUILDING CONCEPTS INC. "METICULOUS ENGINEERING UNPARALLELED DESIGN" 1605 Mono Ave. Minden, N.V. 89423

Phone: (775) 782-8886 Fax: (775) 782-8833

www.bldgconcepts.com

BUILDING CONCEPTS, INC. HEREBY RESERVES
IT'S COMMON LAW COPYRIGHT AND OTHER
PROPERTY RIGHTS IN THESE PLANS, IDEAS, AND
DESIGNS. THESE IDEAS, DESIGNS, AND PLANS ARE NOT TO BE REPRODUCED CHANGED, OR ASSIGNED TO ANY THIRD PARTY WITHOUT FIRST OBTAINING WRITTEN PERMISSION FROM

BUILDING CONCEPTS, INC. © BUILDING CONCEPTS, INC. 2022

MESA, CA., 91941 19) 572-4296 JAMI 7928 La MI (61)

REVISIONS

FEBRUARY 29, 2024 23176A2.Ø SCALE: 1/4" = 1'-0"

DATE:

JOB#

FILE:

DRAWN BY:

GARAGE HAWKINS

SHEET