Mono County Community Development Department

Planning Division

PO Box 347 Mammoth Lakes CA, 93546 760.924.1800, fax 924.1801 commdev@mono.ca.gov PO Box 8 Bridgeport, CA 93517 (760) 932-5420, fax 932-5431 www.monocounty.ca.gov

PREAPPLICATION REVIEW REQUEST

DATE	
PROJECT NAME	
ANTICIPATED PERMIT OR APPLICATION:	
☐ General Plan Amendment ☐ Specific Pla	an 🛘 Conditional Use Permit 🗖 Director Review
□ Other	
REPRESENTATIVE	
	_CITY/STATE/ZIP
TELEPHONE ()	FAX ()
E-MAIL_	ASSESSOR PARCEL#
REVIEW REQUEST: A preapplication review	by the Mono County Land Development Technical

Advisory Committee (LDTAC) is requested for the following project. Briefly describe below the

type of project, units, square footage, etc. Please attach expanded narrative if available.

PLEASE PROVIDE: Maps, drawings, illustrations and narrative that may be useful for staff review.





6463 Crowley Lake Drive 062-090-004-000

	Print or View Value Notice			
Address	6463 Crowley Lake Drive			
Community	Crowley Lake			
Complex				
Land Use Designation	Estate Residential (ER) 3			
Zoning	NA			
Transient Rental	To Be Determined	Confirm		
Voting Precinct	07 - Long Valley			
Supervisor District	Dist #2: Rhonda Duggan			
Lot Size	5.2 acres			
Previous Assessment #	006209004000000			
Latitude/Longitude	37.557068, -118.711633			

THE CRALL COGAN RESIDENCE

6463 CROWLEY LAKE DRIVE MAMMOTH LAKES, CA 93546





WILDLAND URBAN INTERFACE 2018 INTERNATIONAL WILDFIRE URBAN INTERFACE FIRE CODE (WUI)

SECTION 504 CLASS 1 IGNITION-RESISTANT CONSTRUCTION

504.1 GENERAL

CLASS 1 IGNITION-RESISTANT CONSTRUCTION SHALL BE IN ACCORDANCE WITH SECTIONS 504.2 THROUGH 504.11.

504.2 ROOF COVERING
ROOFS SHALL HAVE A ROOF ASSEMBLY THAT COMPLIES WITH A CLASS A RATING WHEN TESTED IN ACCORDANCE
WITH ASTM E 108 OR UL 790. FOR ROOF COVERINGS WHERE THE PROFILE ALLOWS A SPACE BETWEEN THE ROOF
COVERING AND ROOF DECKING, THE SPACE AT THE EAVE ENDS SHALL BE FIRESTOPPED TO PRECLUDE ENTRY OF
FLAMES OR EMBERS, OR HAVE ONE LAYER OF 72-POUND (32.4 KG) MINERAL-SURFACED, NONPERFORATED CAP
SHEET COMPLYING WITH ASTM D 3909 INSTALLED OVER THE COMBUSTIBLE DECKING.

504.2.1 ROOF VALLEYSWHEN PROVIDED, VALLEY FLASHINGS SHALL BE NOT LESS THAN 0.019 INCH (0.48 MM) (NO. 26 GALVANIZED SHEET GAGE) CORROSION-RESISTANT METAL INSTALLED OVER A MINIMUM 36-INCH-WIDE (914 MM) UNDERLAYMENT CONSISTING OF ONE LAYER OF 72-POUND (32.4 KG) MINERAL-SURFACED, NONPERFORATED CAP SHEET COMPLYING WITH ASTM D 3909 RUNNING THE FULL LENGTH OF THE VALLEY.

504.3 PROTECTION OF EAVES

EAVES AND SOFFITS SHALL BE PROTECTED ON THE EXPOSED UNDERSIDE BY IGNITION-RESISTANT MATERIALS OR
BY MATERIALS APPROVED FOR NOT LESS THAN 1-HOUR FIRE-RESISTANCE-RATED CONSTRUCTION, 2-INCH (51 MM)
NOMINAL DIMENSION LUMBER, OR 1-INCH (25 MM) NOMINAL FIRE-RETARDANT-TREATED LUMBER OR 3/4 -INCH (19.1
MM) NOMINAL FIRE-RETARDANT-TREATED PLYWOOD, IDENTIFIED FOR EXTERIOR USE AND MEETING THE
REQUIREMENTS OF SECTION 2303.2 OF THE INTERNATIONAL BUILDING CODE. FASCIAS ARE REQUIRED AND SHALL BE
PROTECTED ON THE BACKSIDE BY IGNITION-RESISTANT MATERIALS OR BY MATERIALS APPROVED FOR NOT LESS
THAN 1-HOUR FIRE-RESISTANCE-RATED CONSTRUCTION OR 2-INCH (51 MM) NOMINAL DIMENSION LUMBER.

GUTTERS AND DOWNSPOUTS SHALL BE CONSTRUCTED OF NONCOMBUSTIBLE MATERIAL. GUTTERS SHALL BE PROVIDED WITH AN APPROVED MEANS TO PREVENT THE ACCUMULATION OF LEAVES AND DEBRIS IN THE GUTTER.

EXTERIOR WALLS

EXTERIOR WALLS OF BUILDINGS OR STRUCTURES SHALL BE CONSTRUCTED WITH ONE OF THE FOLLOWING

METHODS:

MATERIALS APPROVED FOR NOT LESS THAN 1-HOUR FIRE-RESISTANCE-RATED CONSTRUCTION ON THE EXTERIOR

SIDE

APPROVED NONCOMBUSTIBLE MATERIALS.
 HEAVY TIMBER OR LOG WALL CONSTRUCTION.
 FIRE-RETARDANT-TREATED WOOD ON THE EXTERIOR SIDE. THE FIRE-RETARDANT-TREATED WOOD SHALL BE LABELED FOR EXTERIOR USE AND MEET THE REQUIREMENTS OF SECTION 2303.2 OF THE INTERNATIONAL BUILDING CODE.

4. IGNITION-RESISTANT MATERIALS ON THE EXTERIOR SIDE.
5. SUCH MATERIAL SHALL EXTEND FROM THE TOP OF THE FOUNDATION TO THE UNDERSIDE OF THE ROOF SHEATHING.

504.6 UNDERFLOOR ENCLOSUREBUILDINGS OR STRUCTURES SHALL HAVE UNDERFLOOR AREAS ENCLOSED TO THE GROUND WITH EXTERIOR WALLS IN ACCORDANCE WITH SECTION 504.5.

EXCEPTION: COMPLETE ENCLOSURE SHALL NOT BE REQUIRED WHERE THE UNDERSIDE OF EXPOSED FLOORS AND EXPOSED STRUCTURAL COLUMNS, BEAMS AND SUPPORTING WALLS ARE PROTECTED AS REQUIRED FOR EXTERIOR 1-HOUR FIRE-RESISTANCE-RATED CONSTRUCTION OR HEAVY TIMBER CONSTRUCTION OR

1-HOUR FIRE-RESISTANCE-RATED CONSTRUCTION OR HEAVY TIMBER CONSTRUCTION OR FIRE-RETARDANT-TREATED WOOD. THE FIRE-RETARDANT-TREATED WOOD SHALL BE LABELED FOR EXTERIOR USE AND MEET THE REQUIREMENTS OF SECTION 2303.2 OF THE INTERNATIONAL BUILDING CODE.

504.7 APPENDAGES AND PROJECTIONS

UNENCLOSED ACCESSORY STRUCTURES ATTACHED TO BUILDINGS WITH HABITABLE SPACES AND PROJECTIONS, SUCH AS DECKS, SHALL BE NOT LESS THAN 1-HOUR FIRE-RESISTANCE-RATED CONSTRUCTION, HEAVY TIMBER CONSTRUCTION OR CONSTRUCTED OF ONE OF THE FOLLOWING:

1. APPROVED NONCOMBUSTIBLE MATERIALS.

2. FIRE-RETARDANT-TREATED WOOD IDENTIFIED FOR EXTERIOR USE AND MEETING THE REQUIREMENTS OF SECTION 2303.2 OF THE INTERNATIONAL BUILDING CODE.
3. IGNITION-RESISTANT BUILDING MATERIALS IN ACCORDANCE WITH SECTION 503.2.

504.7.1 UNDERFLOOR AREAS


504.9 EXTERIOR DOORS


WHERE THE ATTACHED STRUCTURE IS LOCATED AND CONSTRUCTED SO THAT THE STRUCTURE OR ANY PORTION THEREOF PROJECTS OVER A DESCENDING SLOPE SURFACE GREATER THAN 10 PERCENT, THE AREA BELOW THE STRUCTURE SHALL HAVE UNDERFLOOR AREAS ENCLOSED TO WITHIN 6 INCHES (152 MM) OF THE GROUND, WITH EXTERIOR WALL CONSTRUCTION IN ACCORDANCE WITH SECTION 504.5.


EXTERIOR GLAZING EXTERIOR GLAZING EXTERIOR WINDOWS, WINDOW WALLS AND GLAZED DOORS, WINDOWS WITHIN EXTERIOR DOORS, AND SKYLIGHTS SHALL BE TEMPERED GLASS, MULTILAYERED GLAZED PANELS, GLASS BLOCK OR HAVE A FIRE PROTECTION RATING OF NOT LESS THAN 20 MINUTES.

EXTERIOR DOORS SHALL BE APPROVED NON-COMBUSTIBLE CONSTRUCTION, SOLID CORE WOOD NOT LESS THAN 13/4 INCHES THICK (44 MM), OR HAVE A FIRE PROTECTION RATING OF NOT LESS THAN 20 MINUTES. WINDOWS WITHIN DOORS AND GLAZED DOORS SHALL BE IN ACCORDANCE WITH SECTION 504.8. EXCEPTION: VEHICLE ACCESS DOORS.

ATTIC VENTILATION OPENINGS, FOUNDATION OR UNDERFLOOR VENTS, OR OTHER VENTILATION OPENINGS IN VERTICAL EXTERIOR WALLS AND VENTS THROUGH ROOFS SHALL NOT EXCEED 144 SQUARE INCHES (0.0929 M2) EACH. SUCH VENTS SHALL BE COVERED WITH NONCOMBUSTIBLE CORROSION-RESISTANT MESH WITH OPENINGS NOT TO EXCEED 1/4 INCH (6.4 MM), OR SHALL BE DESIGNED AND APPROVED TO PREVENT FLAME OR EMBER PENETRATION INTO THE STRUCTURE.

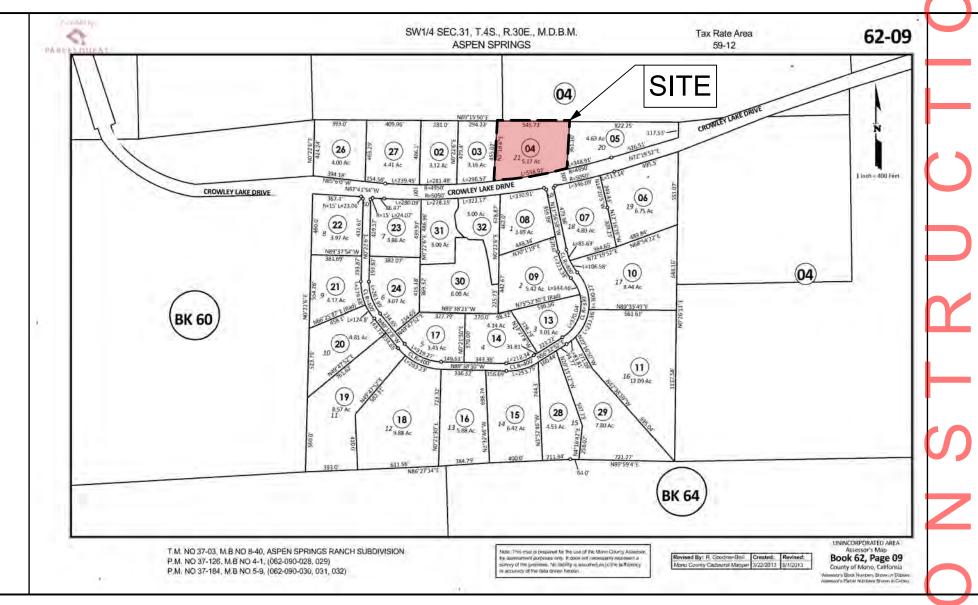

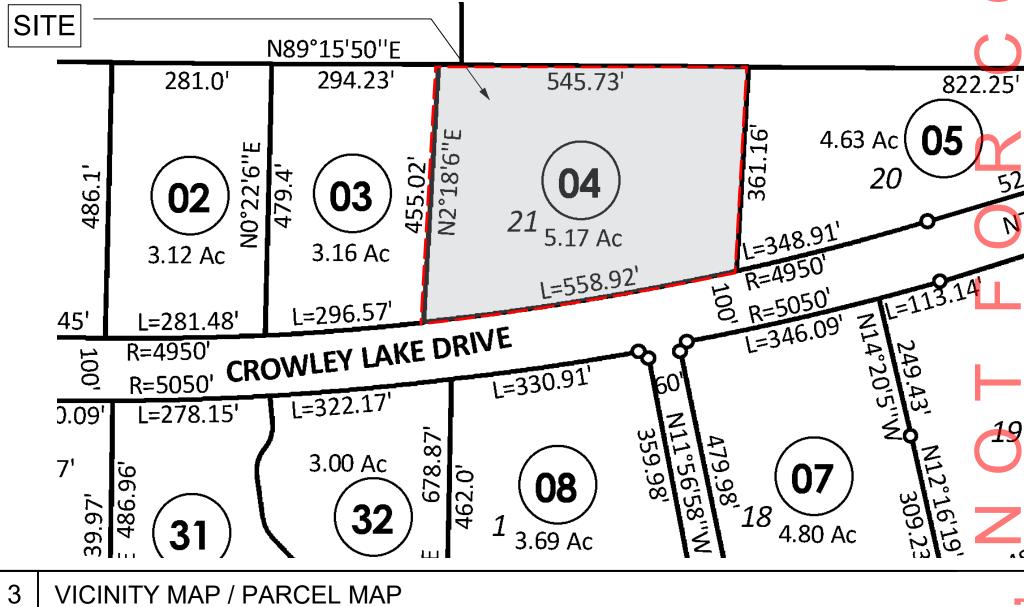

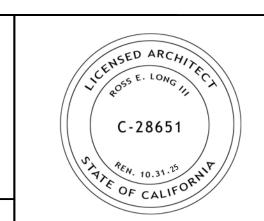


ISSUE
50% DESIGN
100% DESIGN

DATE

120723

021524

ARCHITECT

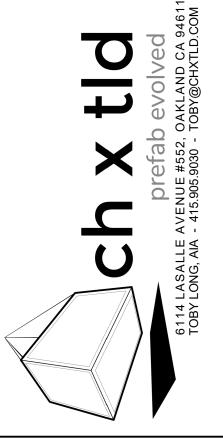

MODULAR FABRICATOR

APPROVAL STAMP

CRALL COGAN RESIDENCE 6463 CROWLEY LAKE DRIVE MAMMOTH LAKES, CA 93546 APN: 62-090-04

INFO


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scale

A 0.1
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CONCEPTUAL RENDERINGS 2 INTERNATIONAL WILDLAND URBAN INTERFACE

ARCHITECTURAL	STRUCTURAL	APN#: 62-090-04			OWNER	ARCHITECT	STRUCTURAL	TITLE 24 / MECHANICAL	CIVIL
X A-0.0 COVER AND MATERIALS X A-0.1 PROJECT INFO X A-0.2 NOTES X A-0.3 NOTES - A-0.4.1 FENESTRATION DIAGRAMS - A-0.4.2 WUI INTERFACE REVIEW X A-0.5 MASSING DIAGRAMS X A-0.6 MODULAR DIAGRAMS X A-0.7 AREA CALCULATIONS X A-0.9 RENDERINGS X A-1.1 SURVEY X A-1.2 SITE PLAN - A-1.3 LANDSCAPE PLAN - A-2.0 FOUNDATION PLAN X A-2.1 LEVEL 1 PLAN X A-2.2 LEVEL 2 PLAN X A-2.3 ROOF PLAN X A-2.3 ROOF PLAN X A-2.5 LEVEL 2 RCP/ELECTRICAL PLAN X A-2.5 LEVEL 2 RCP/ELECTRICAL PLAN X A-3.0.1 SITE SECTIONS X A-3.0.1 SITE SECTIONS X A-3.0 BUILDING SECTIONS X A-4.0 EXTERIOR ELEVATIONS X A-4.1 EXTERIOR ELEVATIONS X A-6.1 DETAILS X A-6.3 DETAILS X A-6.3 DETAILS X A-6.4 DETAILS X A-6.5 DETAILS X A-7.0 DOOR & WINDOW SCHEDULES X A-7.1 DOOR & WINDOW SCHEDULES X A-7.1 DOOR & WINDOW SCHEDULES X A-7.1 DOOR & WINDOW SCHEDULES		LAND USE DESIGNATION ESTATE RESIDENTIAL (ER)	THIS P	ROJECT CONSISTS OF THE CONSTRUCTION OF A NEW SINGLE FAMILY	TIM CRALL & BRITT COGAN	TOBY LONG DESIGN	ISE STRUCTURAL ENGINEERS		TRIAD / HOLMES ASSOC.
		CONSTRUCTION TYPE	HOME AND ATTACHED GARAGE		59 SHERWIN STREET MAMMOTH LAKES , CA 93546	6114 LA SALLE AVE #552 OAKLAND, CA 94611 T. 415. 905. 9030 X1	27369 VIA INDUSTRIA TEMECULA, CA 92590 T. 951.600.0075		CIVIL ENGINEERING & LAND SURVEY
		SITE AREA 5.17 ACRES		T					P.O BOX 1570, MAMMOTH LAKES, CA 93546
		PARKING ATTACHED GARAGE 3 SPACES REQUIRED	6 PROJ	6 PROJECT DESCRIPTION	E: TCRALL@GMAIL.COM E: BRITTCOGAN@HOTMAIL.COM	C. 510.333.3447 M CONTACT: TOBY LONG, AIA E: TOBY@CHXTLD.COM	C. 951.440.9178 CONTACT: SHANE LOTHROP,COO E: SHANE@ISEENGINEERS.COM		CONTACT: TOM PLATZ, PE
		HEIGHT RESTRICTION 35'-0"	2023 C	2023 CA BUILDING CODE 2023 CA MECHANCAL CODE 2023 CA ENERGY CODE 2023 CA PLUMBING CODE 2023 CA GREEN CODE 2023 CA ELECTRICAL CODE 2023 CA RESIDENTIAL CODE	1				T: (760) 934-7588 E: <u>TRIAD@THAINC.COM</u>
		FRONT SETBACK 50'-0" SIDE SETBACKS 30'-0"	2023 C						
	MECHANICAL	SIDE SETBACKS 30'-0" REAR SETBACK 30'-0"							
		LOT COVERAGE 40% MAXIMUM	7 CODE	REFERENCE	GEOTECH	SURVEY	LANDSCAPE	MODULAR FABRICATOR	GENERAL CONTRACTOR
	ELECTRICAL	CLIMATE ZONE 16						+	(')
		SEISMIC DESIGN CATEGORY D	W-## SCHEDUL	REFERENCE REFERENCE Sheet No. REFERENCE	SIERRA GEOTECHNICAL SERVICES, INC. P.O. BOX 5024 MAMMOTH LAKES, CA 93546	TRIAD / HOLMES ASSOC. CIVIL ENGINEERING & LAND SURVEY P.O BOX 1570,			WL HARDER INC. P.O. BOX 9174
	PLUMBING	FROST DEPTH 18" WIND LOAD PER THE 2022 CBC AND CRC	REFEREN						MAMMOTH LAKES, CA 93546
	GROUND SNOW LOAD 125 PSF FLAT ROOF SNOW LOAD 96 PSF	DOOR (D-##) SCHEDUL	D-## SCHEDULE REFERENCE	CONTACT: JOSEPH ADLER, RG, CEG				CONTACT: WILLIAM HARDER T: (760) 934-1869	
		Plan No. WALL ASSEMBLY REFERENCE Plan No. A A6 REFERENCE Sheet No.	T: (760) 937-5608 E: <u>INFO@SGSI.US</u>	CONTACT: TOM PLATZ, PE T: (760) 934-7588 E: TRIAD@THAINC.COM			E: WILLIAM@WLHARDERING.COM		
			#	Sheet No.					
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triad/holmes assoc.
civil engineering
land surveying

MAMMOTH LAKES
BISHOP

REDWOOD CITY
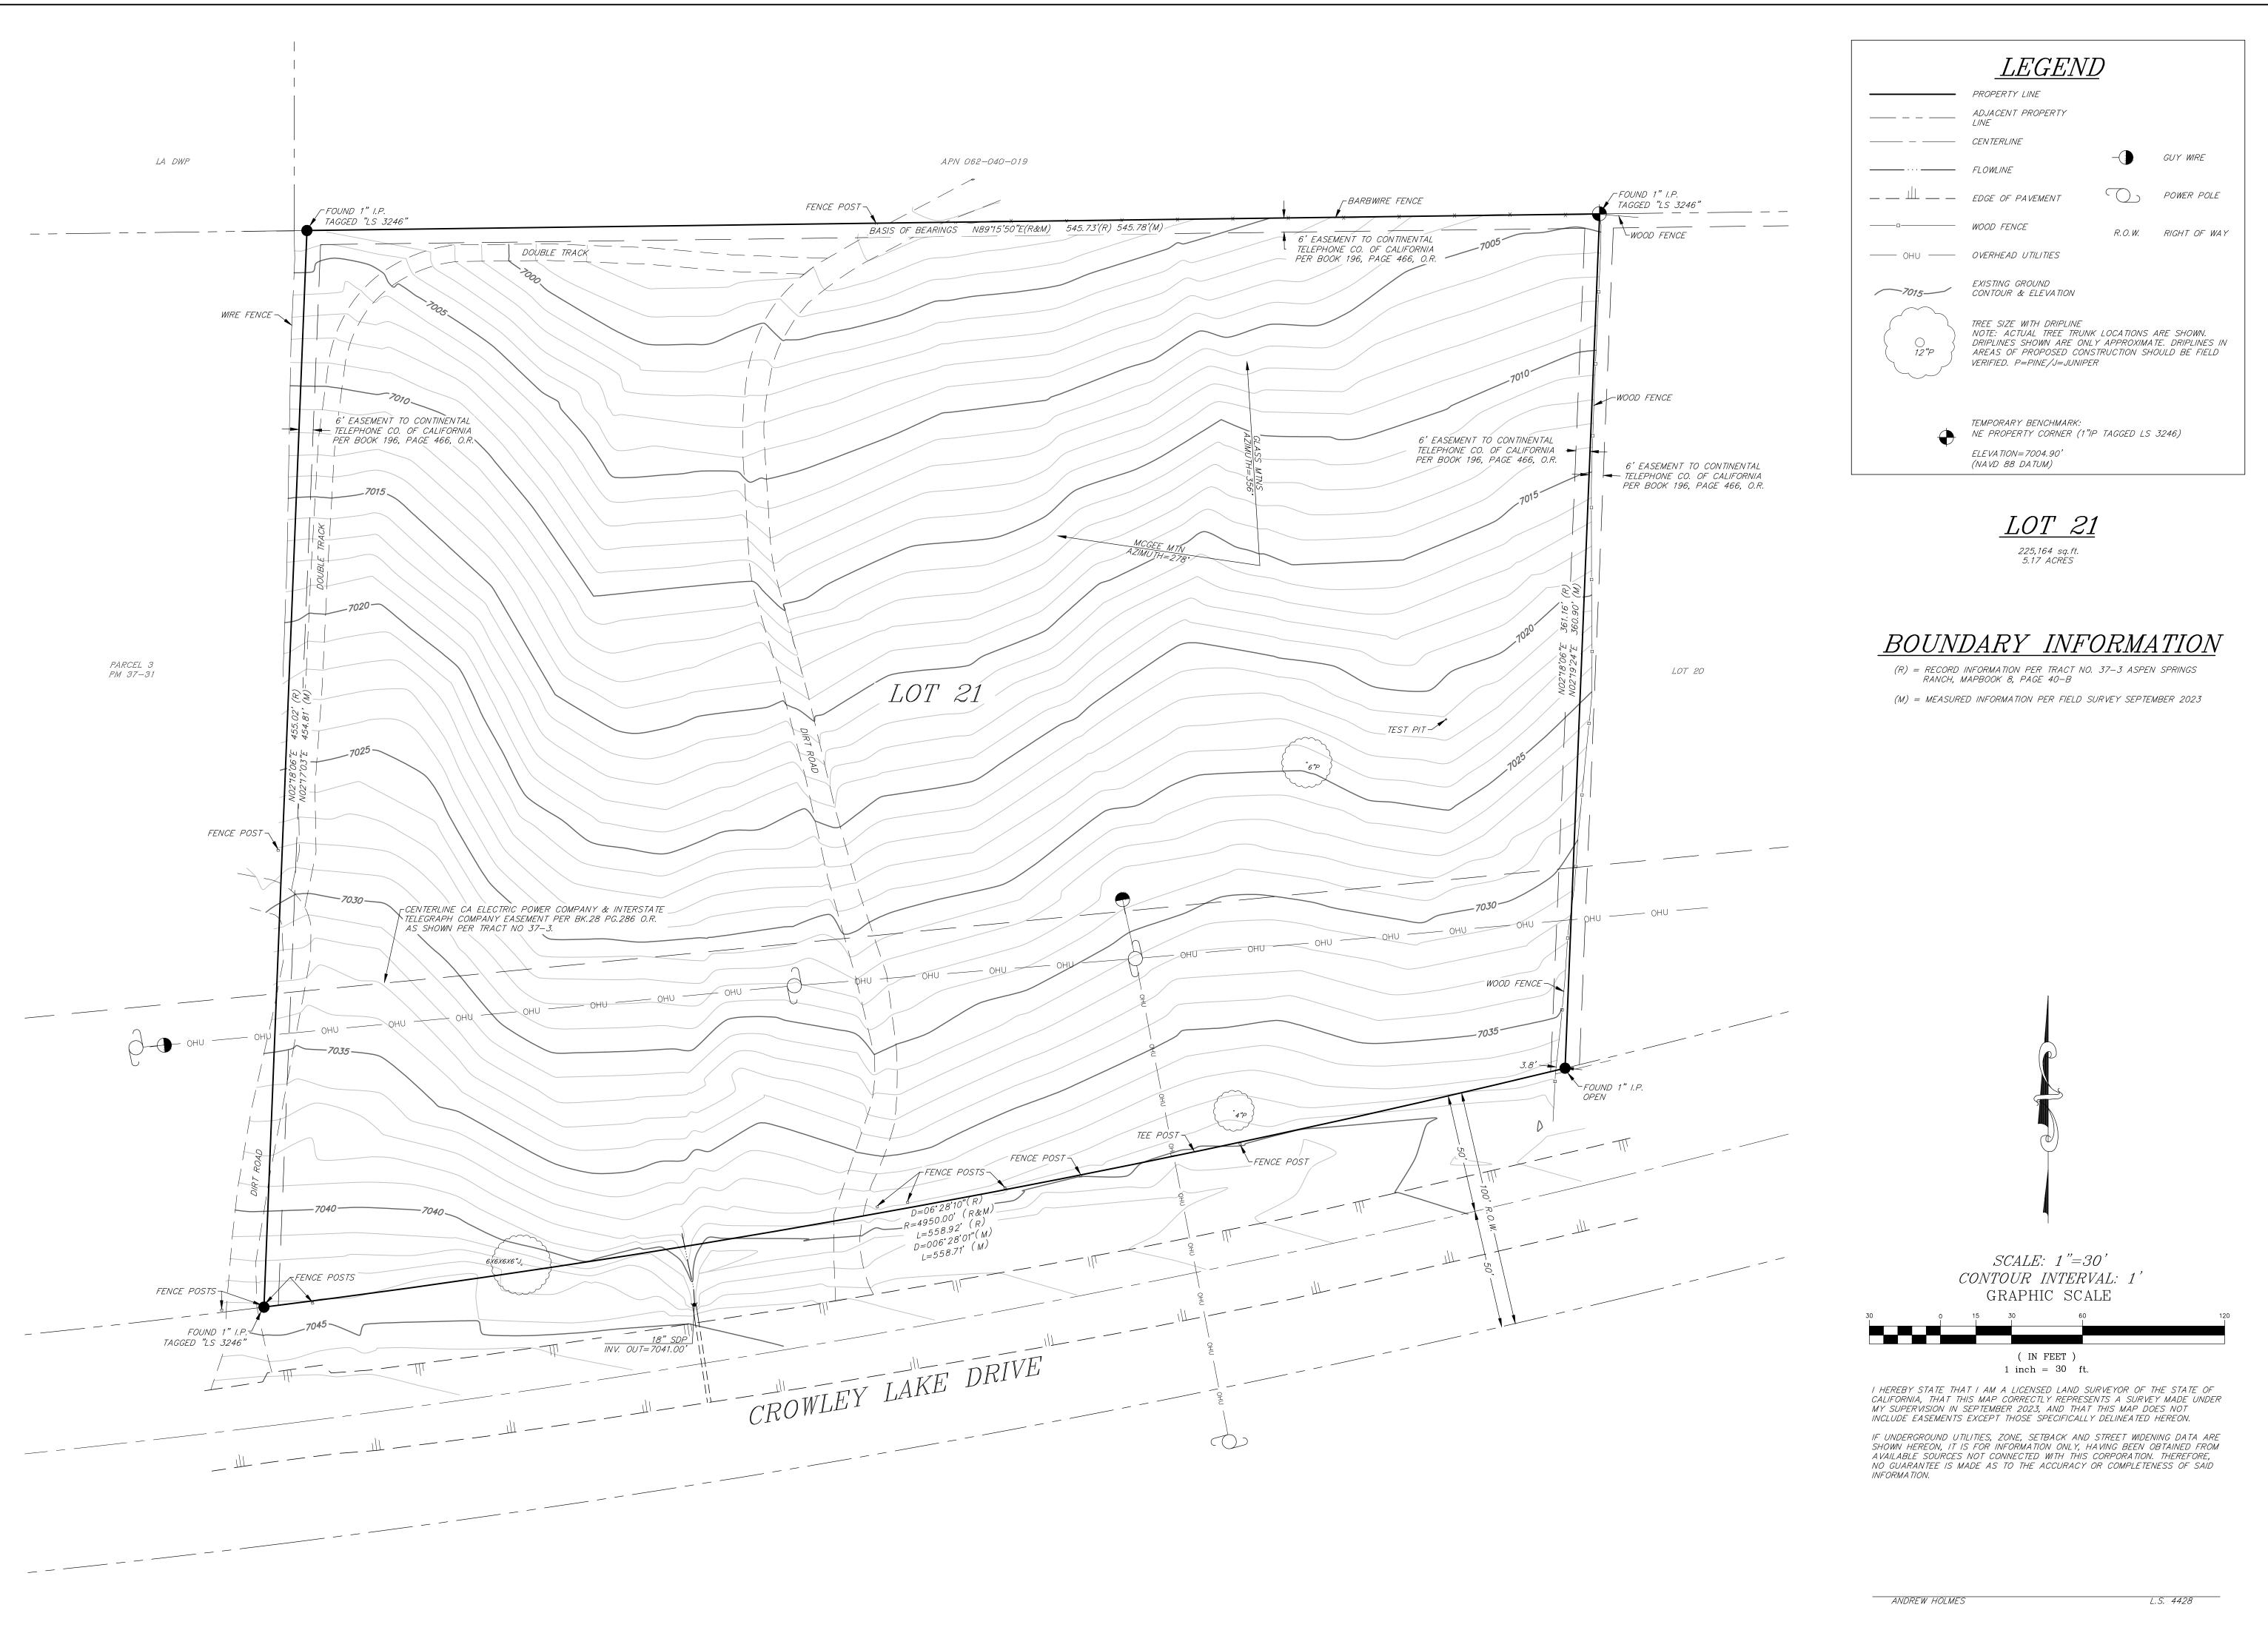
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617-880-9023

N SPRINGS RANCH
TOPOGRAPHIC SURVEY
0, STATE OF CALIFORNIA

LOT 21, ASPEN

TE 9/12/23

ALE 1"=30'

AWN

TJP

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