

CONSTRUCTION DETAILS

ORIGIN DATE: 04/19/21

SHOP OWNER: RA 251 CRAI COLEV .P.N.: 00-02-GILBE

PROJECT

GILBERT CONSTRUCTION CA LIC NO. 747977
P.O. BOX 2
COLEVILLE, CA 96107
(530) 495-2362

R.L CONTRACTOR

Three Castles Engineering, LLC


JOB#: 21007 DRAWN BY: GT


SHEET


SCALE: 1" = 40'-0"



FRONT (NORTH) ELEVATION SCALE: 1/4" = 1'-0"

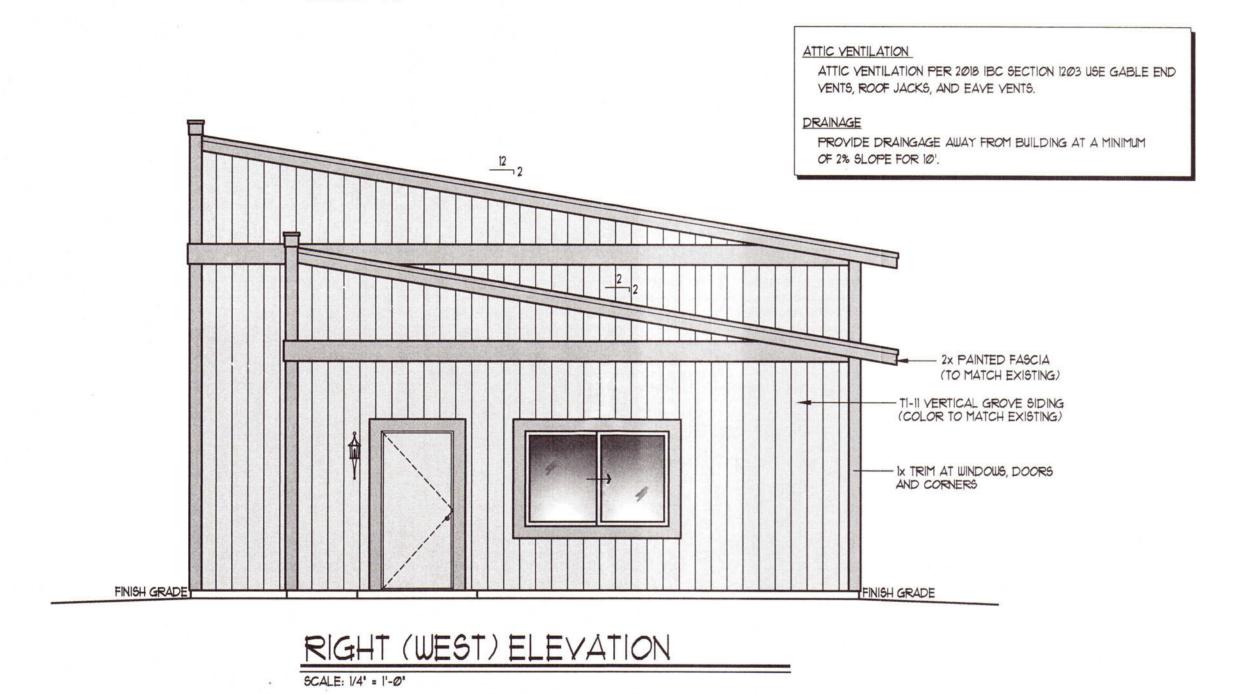

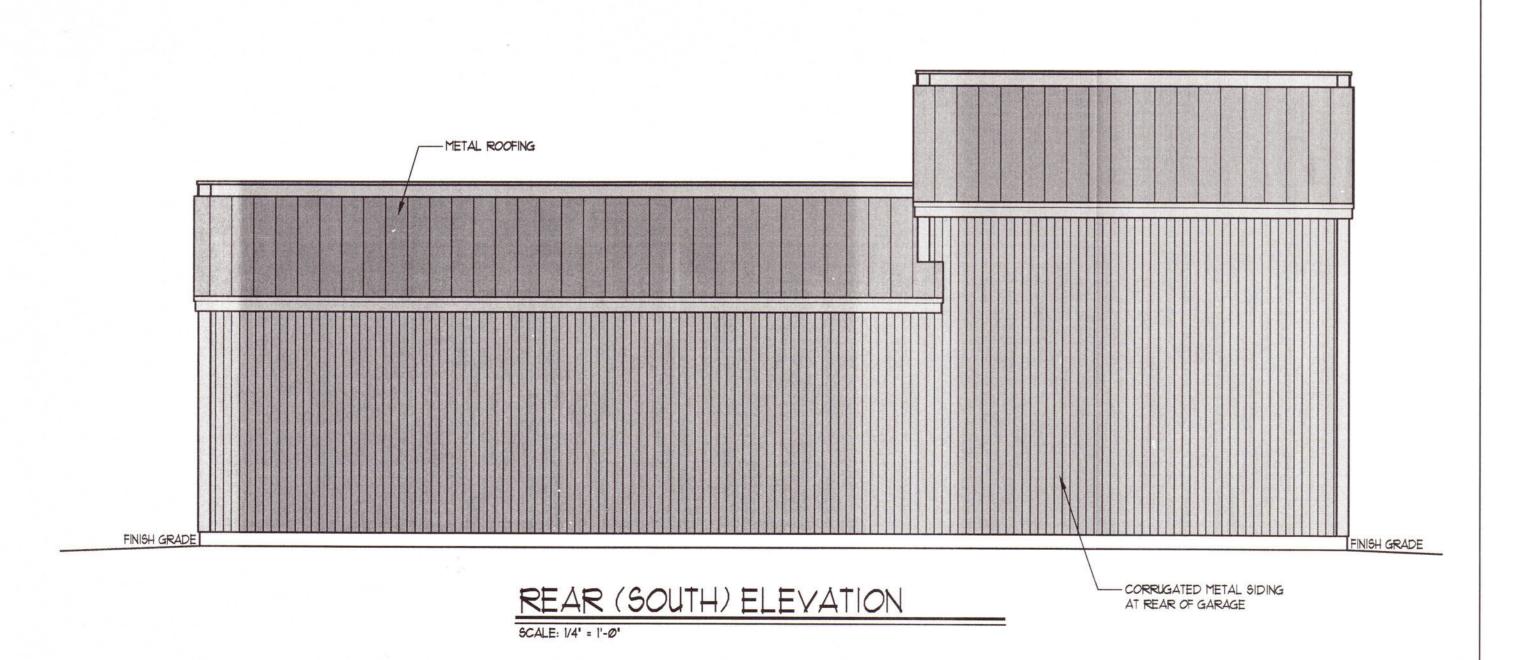

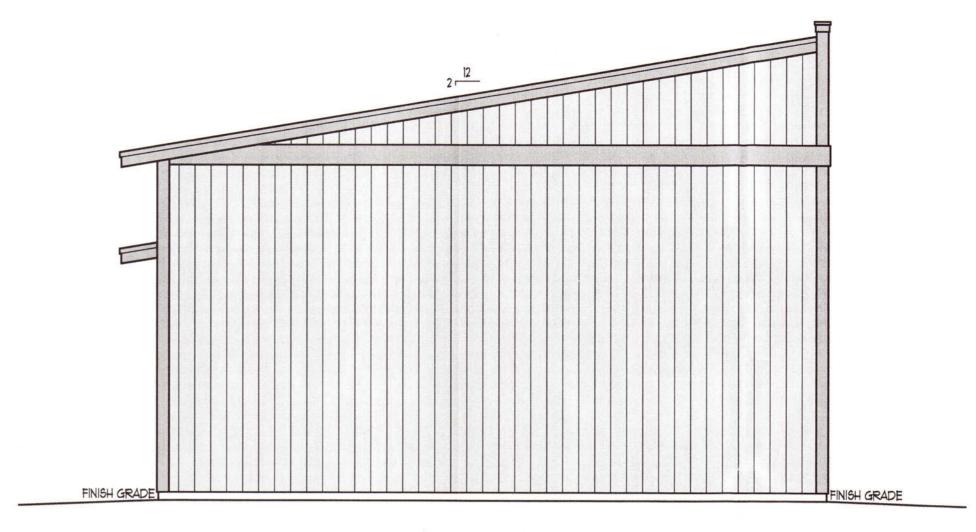

LEFT (EAST) ELEVATION

SCALE: 1/4' = 1'-0'

An Engineering and Consulting Company GARY E. THURM, JR., P.E. #16505 1228 PEP CIRCLE Cardnerville, NV 89410 Phone: (775) 783-1058 e-mail: three castlesengineering@charter.net

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STRUCTURAL ENGINEERING NOTES

> - SYMBOL INDICATES SHEAR WALL NAILING - SEE SCHEDULE SHEET 53.0
- WHEN NOTED FOR A SPECIFIC SHEAR WALL, FOUNDATION SILL PLATES AND ALL FRAMING MEMBERS RECEIVING EDGE NAILING FROM ABUTTING PANELS SHALL NOT BE LESS THAN A SINGLE 3" NOMINAL MEMBER AND FOUNDATION SILL PLATES SHALL NOT BE LESS THAN A SINGLE 3" NOMINAL MEMBER AT SHEAR WALL NOTED.

- SEE SHEET 63.1 FOR STANDARD STRUCTURAL DETAILS PER APPLICATION. - WHERE POSTS AND MULTIPLE STUDS ARE SPECIFIED, THEY ARE TO BE STACKED IN ALL WALL FRAMING AND SOLID VERTICAL GRAIN BLOCKING SHALL BE PROVIDED AT ALL FLOOR LEVELS DOWN TO THE FOUNDATION. - CONTRACTOR TO PROVIDE TRUSS CALCS FOR REVIEW AND APPROVAL BY PROJECT ENGINEER - DRAG TRUSSES SHALL BE DESIGNED BY TRUSS MANUFACTURER FOR THE INDICATED LOAD FOR REVIEW AND APPROVAL BY PROJECT ENGINEER

SHEAR WALL & ANCHOR BOLTS SCHEDULE

SYMBOL T4	SHEAR PLY REQ'D AND EN SPACING 7/16" T1-11 - 8d @ 4"	SOLE PL."" 16d NAIL SPACING 4" o.c.	50LE PL."" 5D5 1/4'x6' 5PACING 12" o.c.	3X REQ'D	CLIP & " SPACING" A35 - 16"	5/8' DIA ABOLT SPACING" 48"
T6	7/16" T1-11 - 8d @ 6"	6" o.c.	16" o.c.	NO	A35 - 24"	48"
<u></u>	3/8" - 8d @ 6"	6" o.c.	16" o.c.	NO	A35 - 24"	48"
4	3/8" - 8d @ 4"	4" o.c.	12" o.c.	NO	A35 - 16"	48"
	IS A PRODUCT OF TEMPLE INLAND. SHEAR NE ACCORDING THE RECOMMENDATIONS O		CULATIONS ASSUMBE A ER AND CAN BE FOUND			E THESE VALUES

HOLDOWN SCHEDULE

(HII) HHDQII o/ 6x STUD, UNO.

Holdowns Shall Be Installed Per Manufacturers Specifications, UNO.
 Holdown Anchor Bolts Shall Be Installed and Should Meet Manufacturers Minimum Installation Requirements (See table below for Alternative Holdown Anchors and requirements).

Installation Requirements (See table below for Alternative Holdown Anchors and requirements).


- Check Simpson Catalog for Holdown to Stud Fastner Requirements

- SSTB Anchors and All Threaded Rods Should be Tied To (1) *4 Vertical,
Developed Into Fing. w/ 90Deg Bend.

- All End Conditions For Threaded Rods Shall Have (2) Nuts And (1) Washer Per Manufacturer.

- Provide Rim Joist & Blk'g Or Solid Vertical Grain Blocking & HD2A, HD5A, HD6A, HTT4, HTT5

- Provide Solid Vertical Grain Blocking & HDQ8, HDQ11, HD10A, HD16A

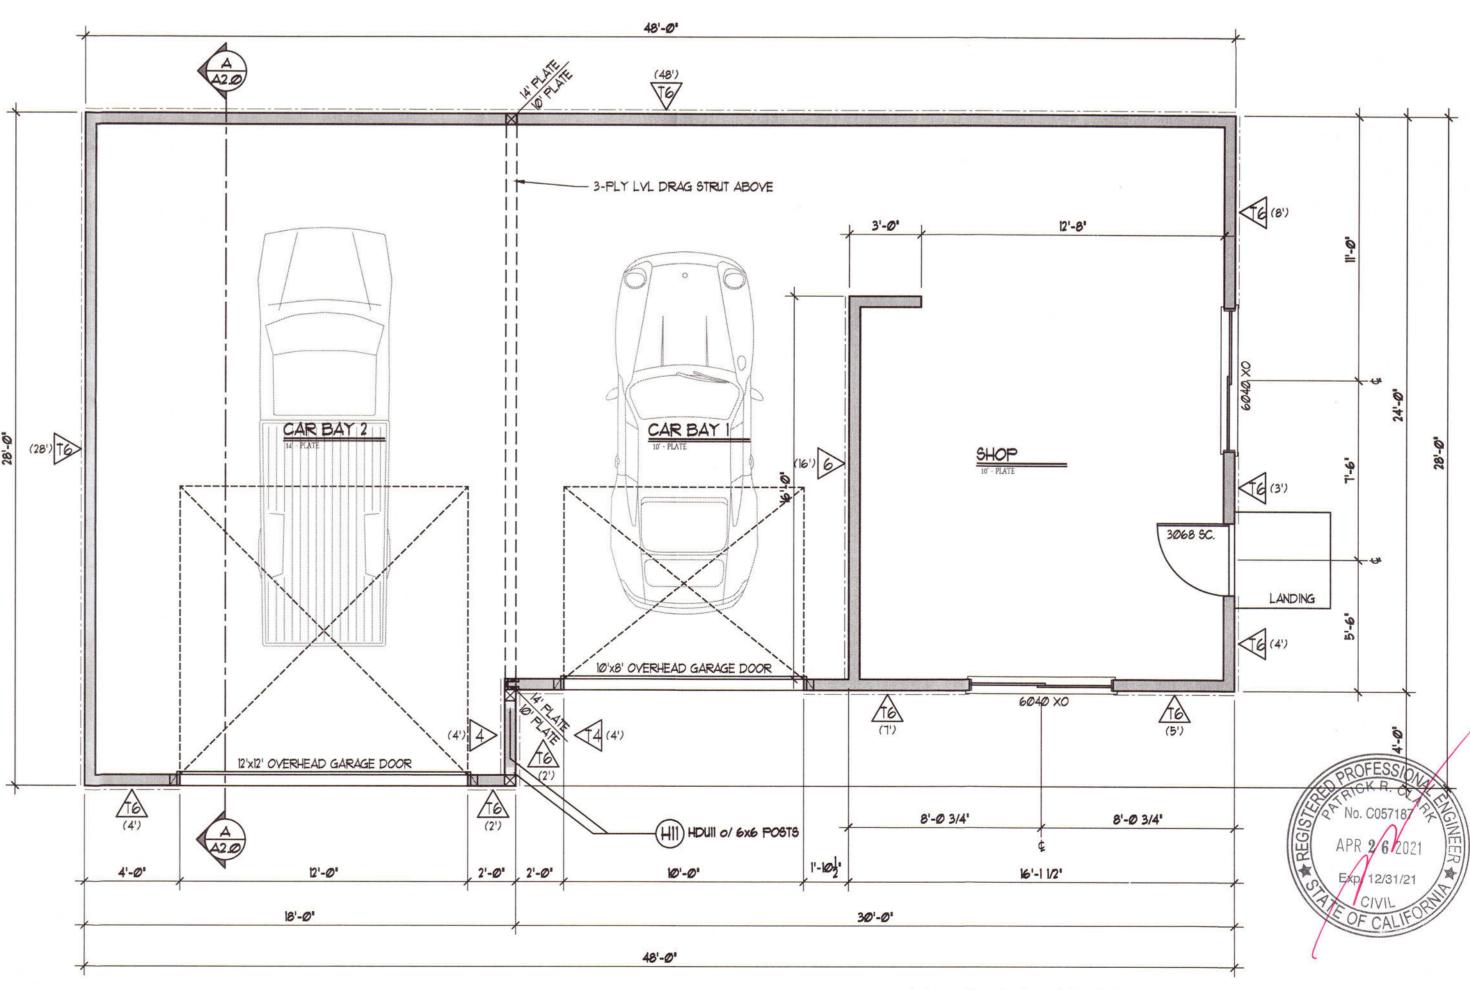

STRUCTURAL FLOOR PLAN

DETACHED GARAGE = 1,224 SQ.FT.

RT SHOP OWNER: RAN 251 CRAN COLEVI A.P.N.: 00-02-1 GILBER


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Al.Ø SHEET Three Castles Engineering, LLC



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Gardnerville, NV 89410
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ORIGIN DATE: 04/19/21

DATE

REVISION

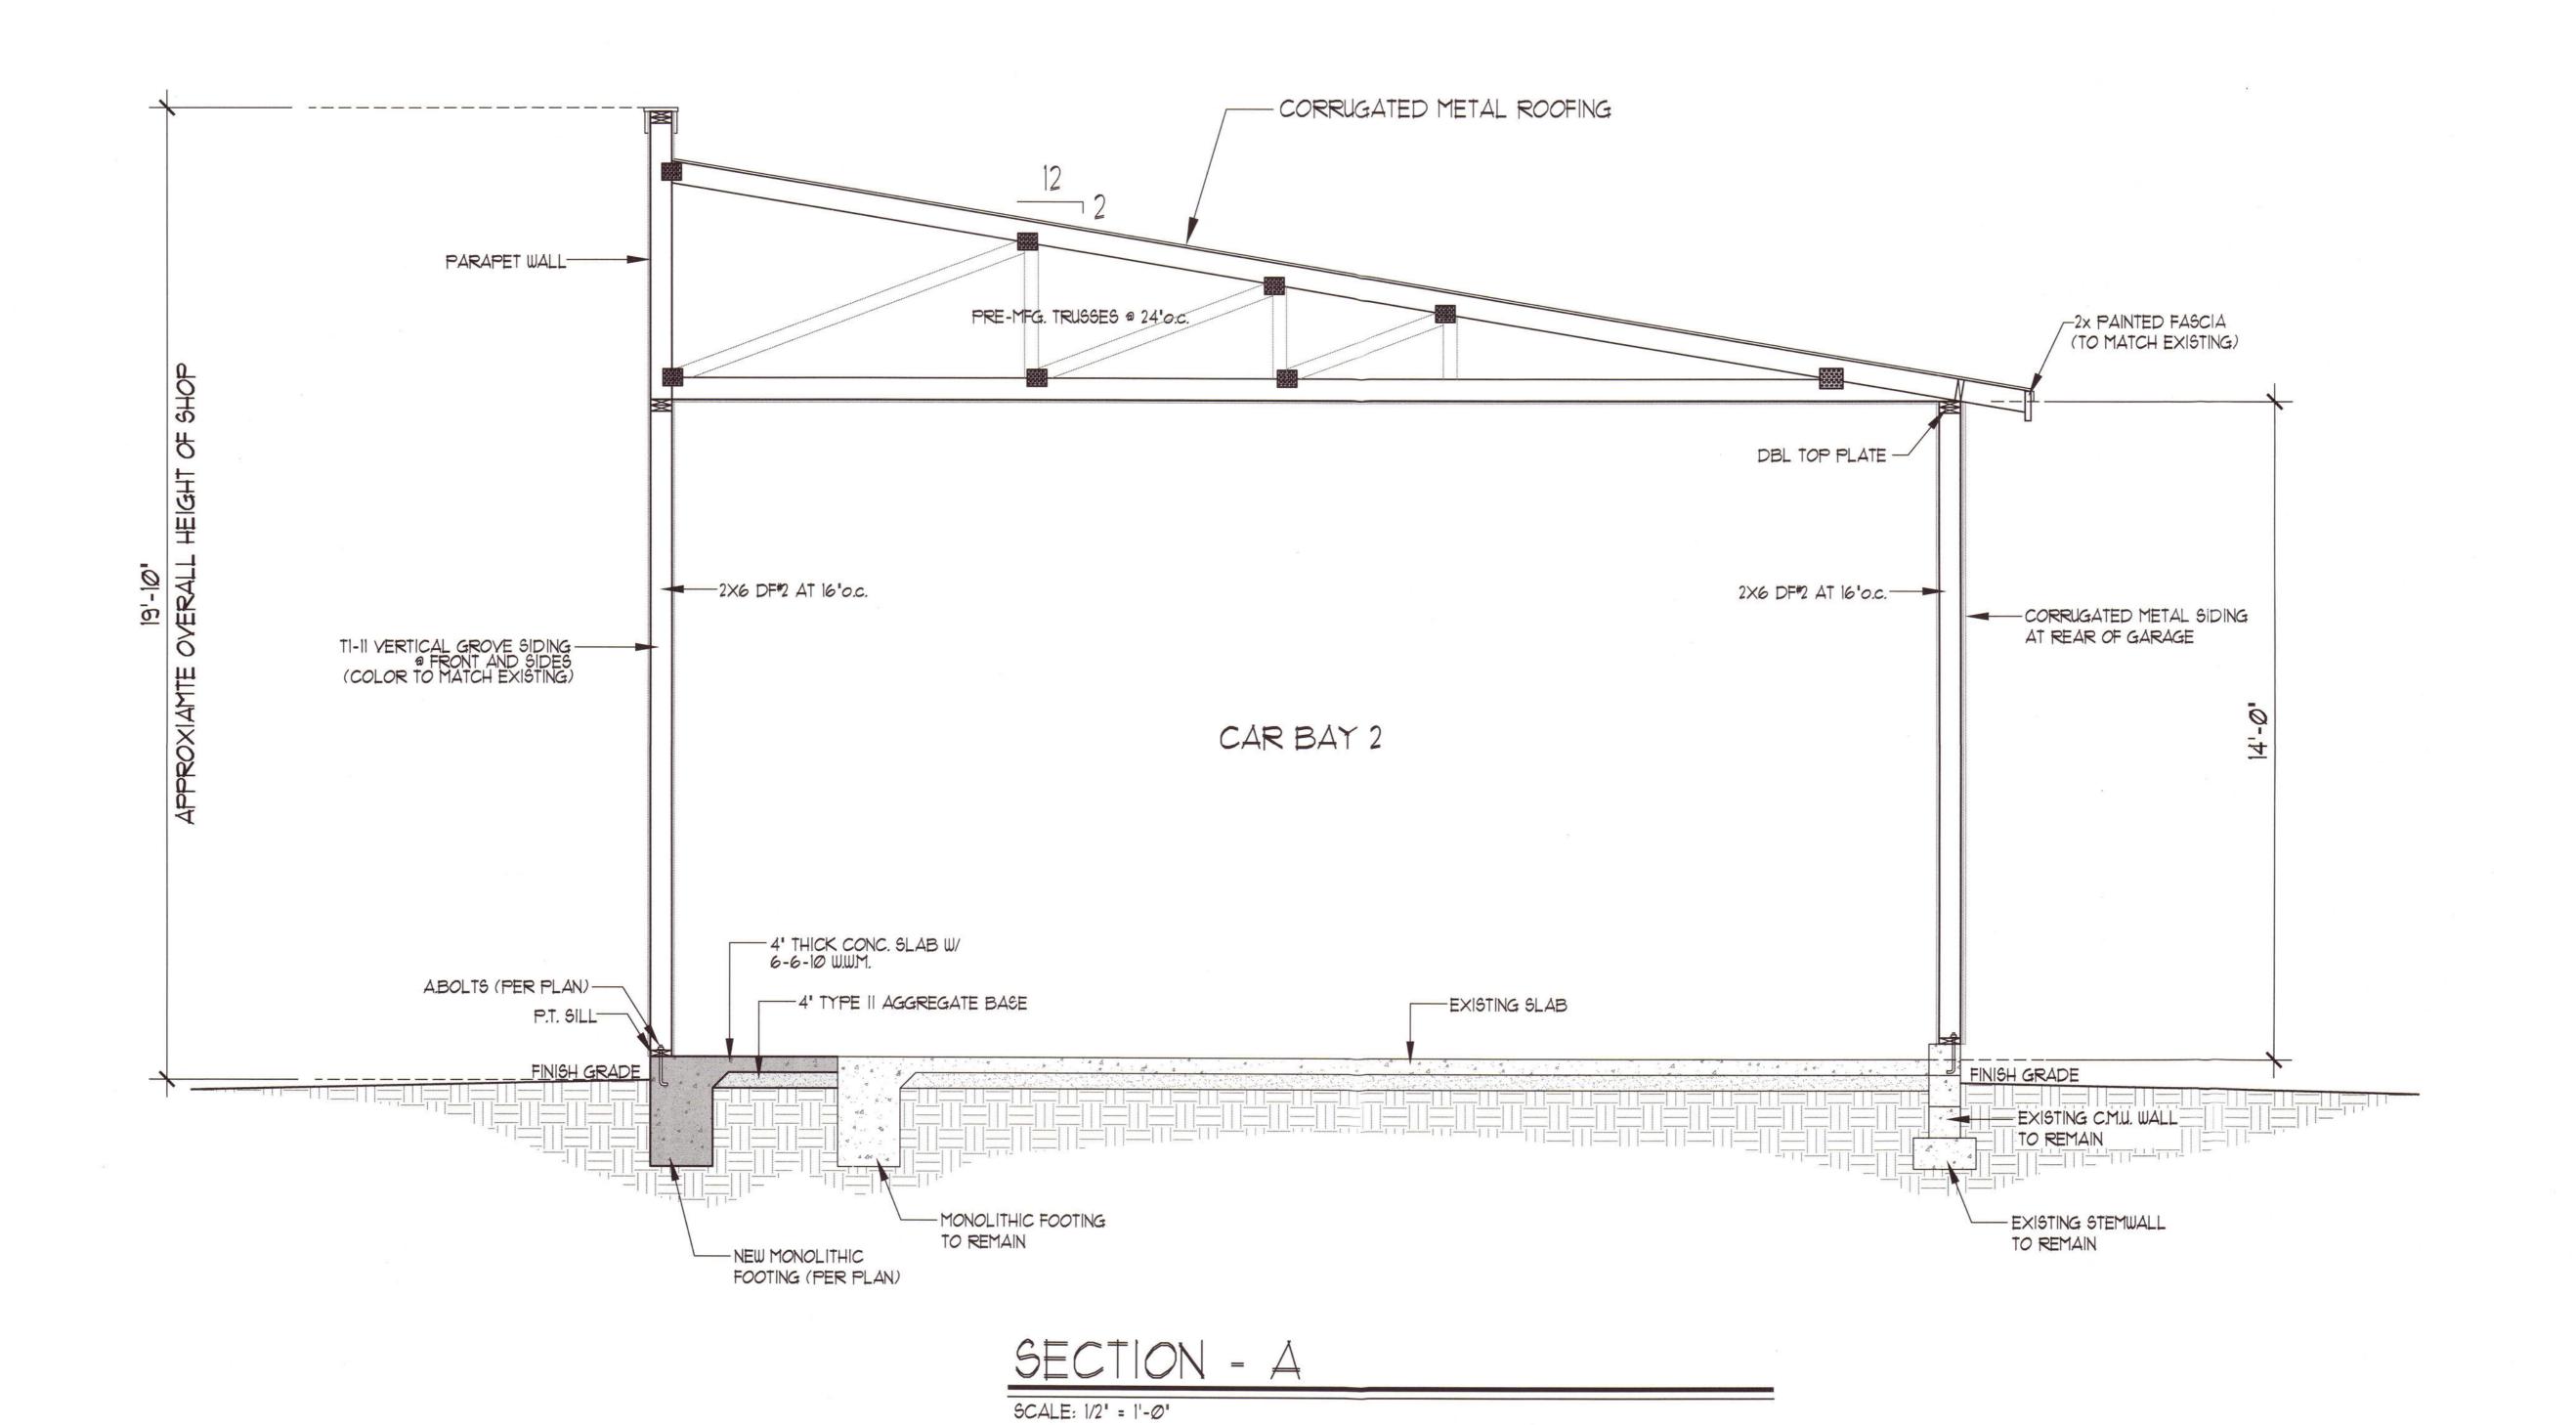GILBERT SHOP

OWNER: RANDY GILBERT 251 CRANNEY LANE COLEVILLE, CA. A.P.N.: 00-02-130-38-0000-00

PROJECT

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CONTRACTOR

DRAWN BY: GT

JOB#: 21007

A2.0 SHEET

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