Addendum to the Negative Declaration for the Mountain Gate Fishing Access Project SCH #2006102041

June 10, 2014

Executive Summary

The Mountain Gate Fishing Access Project (MGFAP) would create a parkway that actively encourages interaction with the West Walker River in the form of fishing, hiking, exercising, picnicking, and/or relaxing regardless of age or ability. The two main recreational opportunities provided by the Mountain Gate Fishing Access Project include ADA accessible fishing and an ADA accessible trail to and/or along the West Walker River. Other amenities include picnic and resting areas, day use facilities, therapeutic exercise stations (a "par course") for senior citizens and disabled persons, accessible restrooms, a side channel restoration, a nature trail, and an interpretive kiosk.

The Initial Study and Negative Declaration for the MGFAP was completed in December of 2006. This addendum is to make minor technical changes, clarifications and non-environmentally significant modifications to the Initial Study and Negative Declaration for MGFAP. The technical change being made to the project will not connect the side channel (the existing riparian area) with the West Walker River and include a constructed wetland. The improvement plans, sheet C1, no longer shows a connection from the West Walker River to the existing riparian area and a constructed wetland.

Addendum Determination

Mono County has determined that an Addendum to Initial Study and Negative Declaration for MGFAP is the appropriate level of environmental review under CEQA. An Addendum is appropriate because the analysis in Table 1 below demonstrates that none of the conditions described in CEQA Guideline Section 15162 have occurred.

CEQA Section 15164 (a) provides that "the lead agency or responsible agency shall prepare an addendum to a previously certified EIR if some changes or additions are necessary but none of the conditions described in Section 15162 calling for preparation of a subsequent EIR have occurred." None of the conditions described in section 15162 have occurred.

Section 15162 provides for the preparation of a subsequent EIR where:

- Substantial changes are proposed in the project, which will require major revisions of the previous EIR or negative declaration due to the involvement of new significant environmental effects or a substantial increase in the severity of previously identified significant effects;
- (2) Substantial changes occur with respect to the circumstances under which the project is undertaken which will require major revisions of the previous EIR or negative declaration due to the involvement of new significant environmental effects or a substantial increase in the severity of previously identified effects;
- (3) New information of substantial importance, which was not known and could not have been known with the exercise of reasonable diligence at the time the previous EIR was certified as complete or the negative declaration was adopted, shows any of the following:
 - a. The project will have one or more significant effects not discussed in the previous EIR or negative declaration;
 - b. Significant effects previously examined will be substantially more severe than shown in the previous EIR;
 - c. Mitigation measures or alternatives previously found not to be feasible would in fact be feasible, and would substantially reduce one or more significant effects of

the project, but the project proponents decline to adopt the measure or alternative; or


d. Mitigation measures or alternatives which are considerably different from those analyzed in the previous EIR would substantially reduce one or more significant effects on the environment but the project proponent declines to adopt the mitigation measure or alternative.


Summary of technical changes made to the Mt. Gate Fishing Access Project – Initial Study/Neg Dec	CEQA guidelines section 15162 Analysis
 Page 14 of Initial Study/Neg Dec IV. Biological Resources b) states: In addition, the project will include a constructed wetland and a side channel restoration. Project has been changed to exclude a constructed wetland and side channel restoration. See Improvement Plans, Mountain Gate Phase 2, Sheet C1. 	The original intent for the constructed wetland and side channel restoration was dependent on a connection to the West Walker River. This direct connection to the river no longer exists and the existing riparian area will not be reconstructed but will remain in its current state. This change will not have an impact to the environment.
 Page 15 of Initial Study/Neg Dec VIII. Hydrology and Water Quality c) states: A side channel restoration project is planned for the sitebecause water will constantly be flowing through. Project has been changed to exclude a constructed wetland and side channel restoration. See Improvement Plans, Mountain Gate Phase 2, Sheet C1. 	The original intent for the constructed wetland and side channel restoration was dependent on a connection to the West Walker River. This direct connection to the river no longer exists and the existing riparian area will not be reconstructed but will remain in its current state. This change will not have an impact to the environment.

Table 1: Review of findings under CEQA Guidelines Section 15162

References

- Negative Declaration Mt. Gate Fishing Access Project December 2006
- Mountain Gate Phase 2 90% Improvement Plans (dated 06/05/14)
- Mountain Gate Fishing Access Park and Channel Restoration Project, Delineation of Waters of the U.S. Including Wetlands HDR Engineering, Inc., July 2010

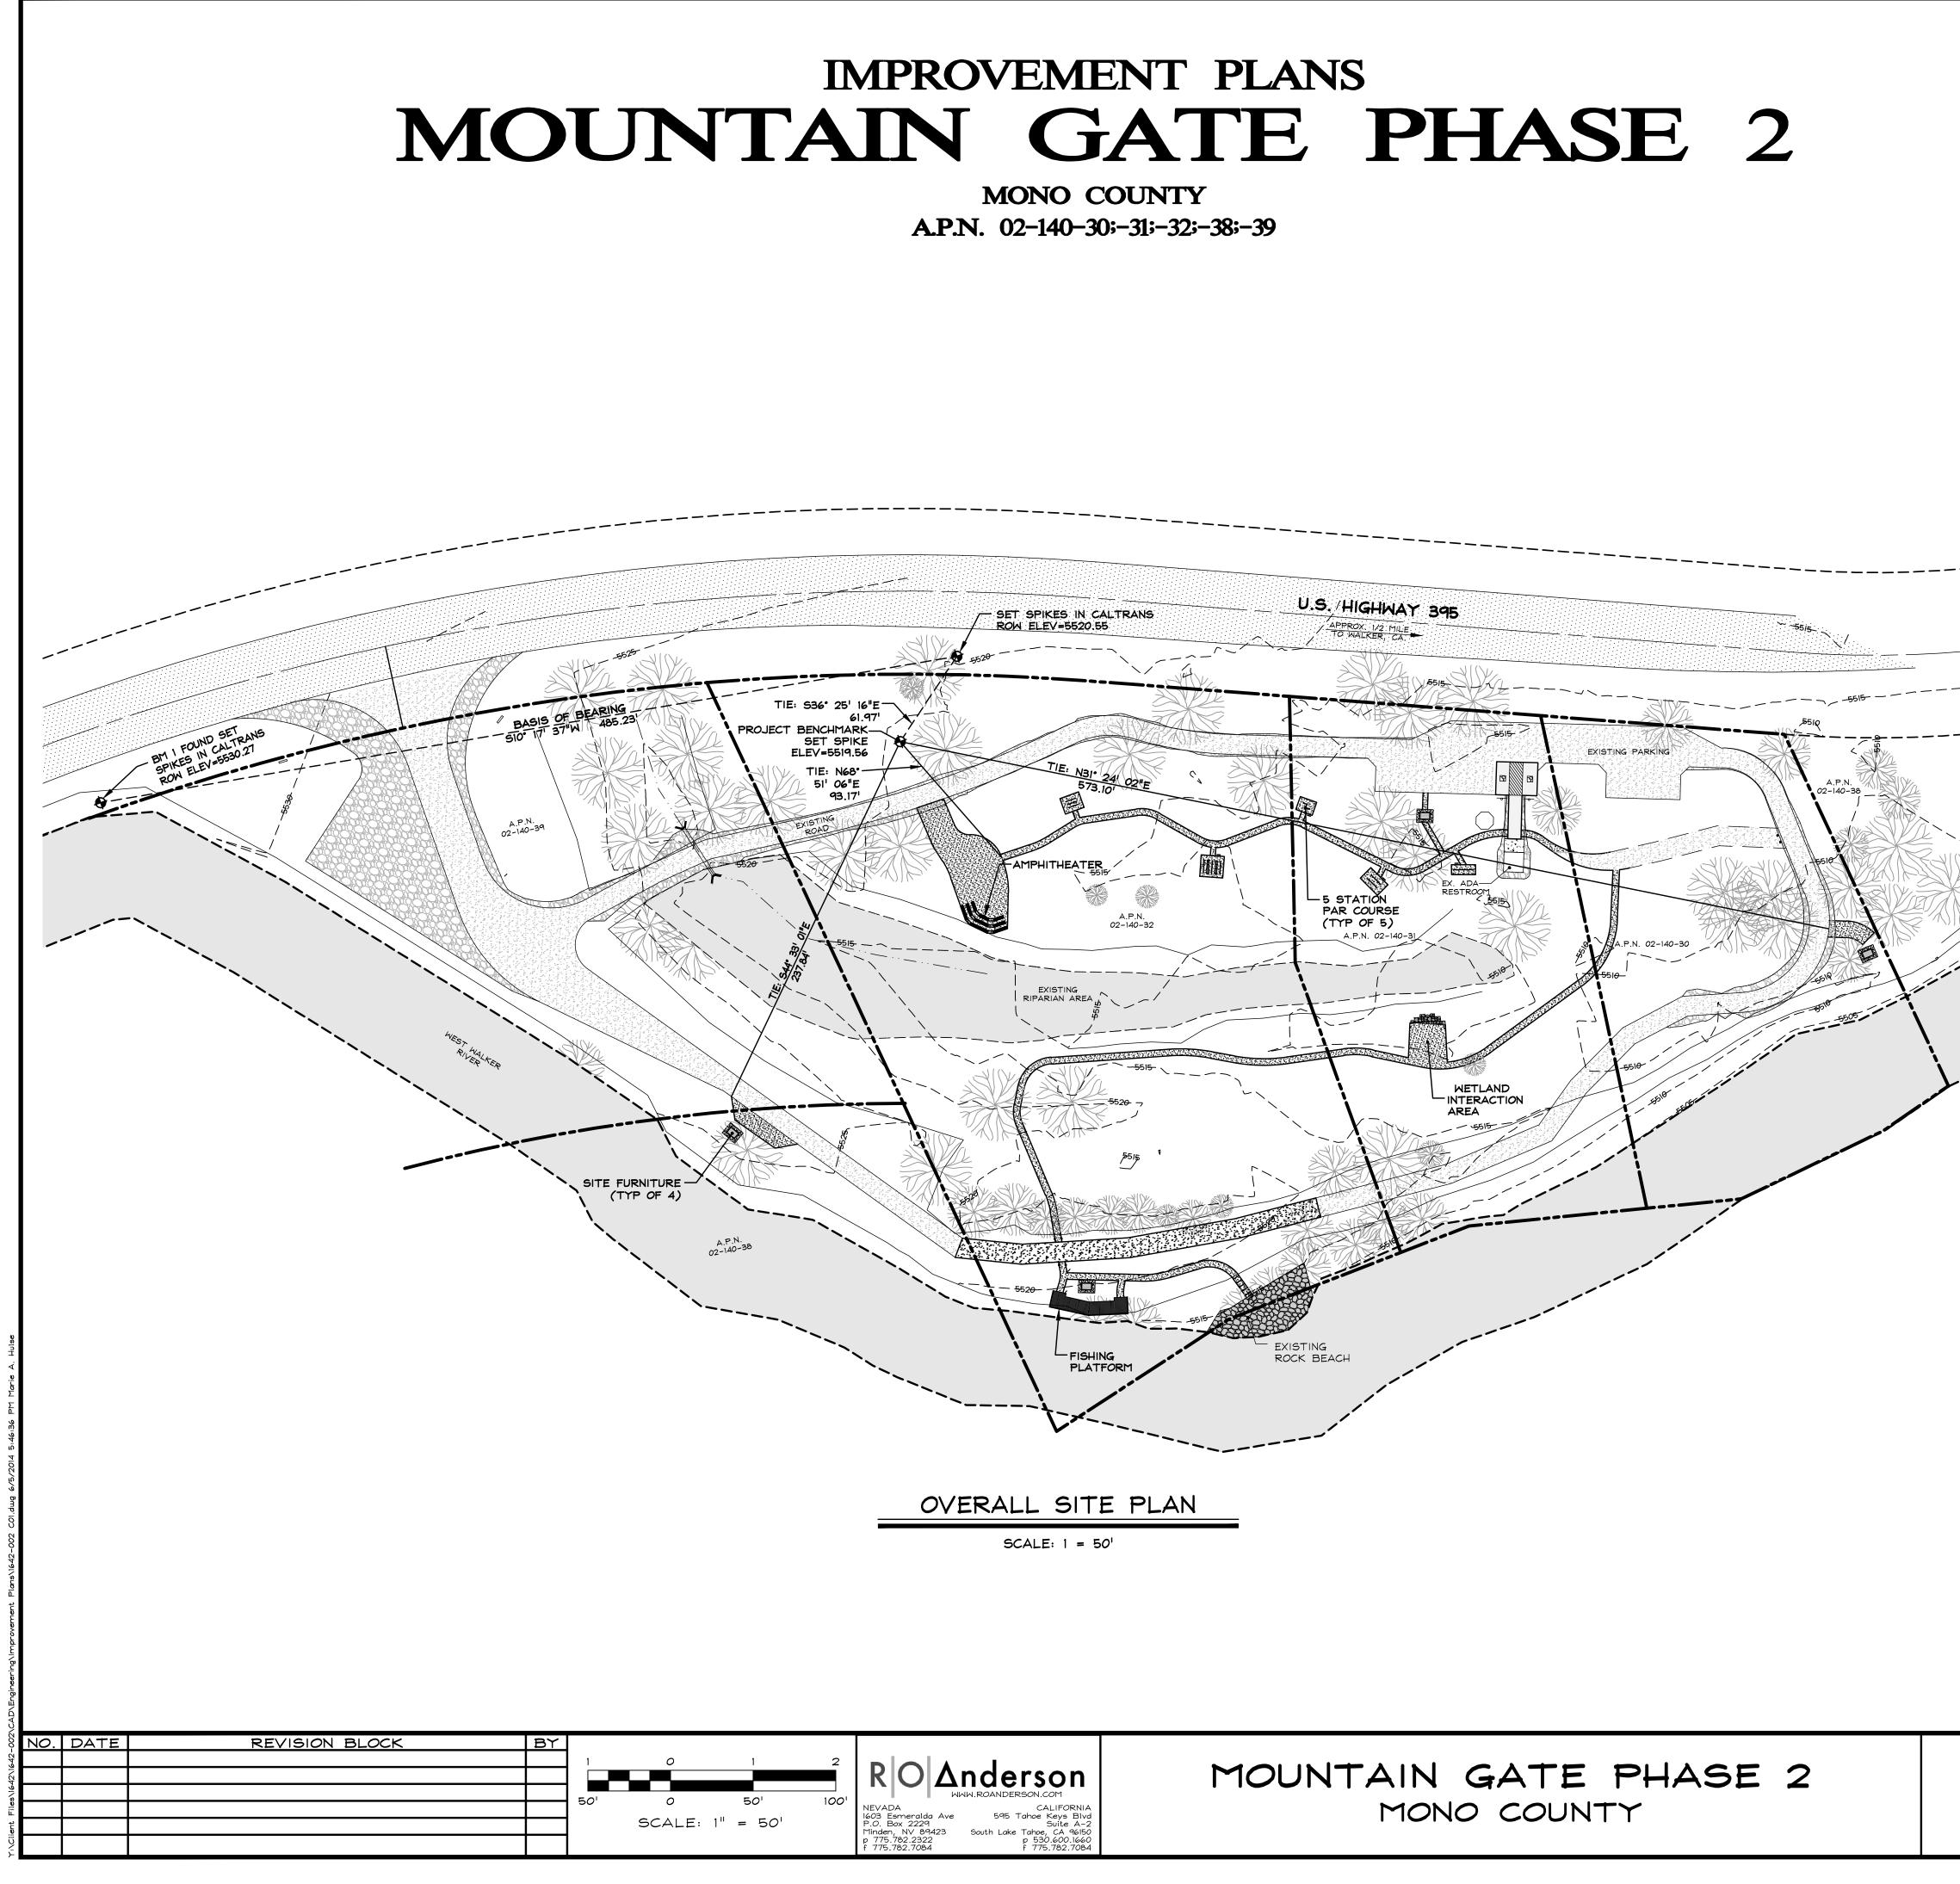

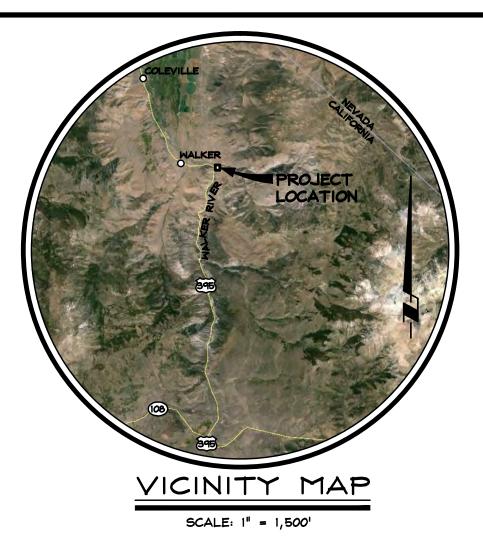

PROJECT SUMMARY

OWNER/APPLICANT:

PHONE:

FAX:

PROJECT ENGINEER: PHONE: FAX:

PROJECT ADDRESS: A.P.N.: CURRENT LAND USE:

PROJECT AREA: FLOOD ZONE:

MONO COUNTY DEPT. OF PUBLIC WORKS P.O. BOX 457 74 N. SCHOOL STREET BRIDGEPORT, CA 93517 (760) 932-5446 (760) 932-5441 R.O. ANDERSON ENGINEERING, LLC. 1603 ESMERALDA AVE, MINDEN, NV 89423 (775) 782-2322 (775) 782-7084 U.S. HIGHWAY 395 WALKER, CALIFORNIA 02-140-30;-31;-32;-38;-39 MU1 \$ RR10

15 AC AE FLOODWAY AREA PER F.I.R.M. 06051C0089D DATED FEBRUARY 18,

SHEET INDEX

- COVER SHEET LEGEND, ABBREVIATIONS, & NOTES EXISTING CONDITIONS, DEMOLITION, & EROSION CONTROL PLAN Cl C2 СЗ
- SITE PLAN C4 GRADING PLAN C5
- GRADING PLAN DETAILS C6 C7
- C8 DETAILS
- LANDSCAPE LEGEND, NOTES & DETAILS SITE LANDSCAPE PLAN & DETAILS IRRIGATION LEGEND, NOTES & DETAILS SITE IRRIGATION PLAN L2
- L3 14


APPROVALS

MONO COUNT

R.O. ANDERSON ENGINEERING, INC.

DATE

DATE

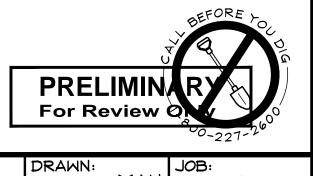

COVER SHEET

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BED PROI LOSTONAL	DRAWN: MAH	JOB: 1642-002	
JEREMY J. HUTCHINGS	ENGINEER:	DRAWING: 1642-002C01	ł
★ Exp. 09-30-15 ★	SCALE: 1" = 50'	SHEET:	
STATE OF ON LEORNIT	DATE: 06/05/14	OF: 9 SHEETS	